

# IMPROVEMENT PLANS

FOR

# LAKERIDGE UNIT 1B A PORTION OF PARCEL "A" OF WALLACE LAKE ESTATES, UNIT 1, TRACT 434

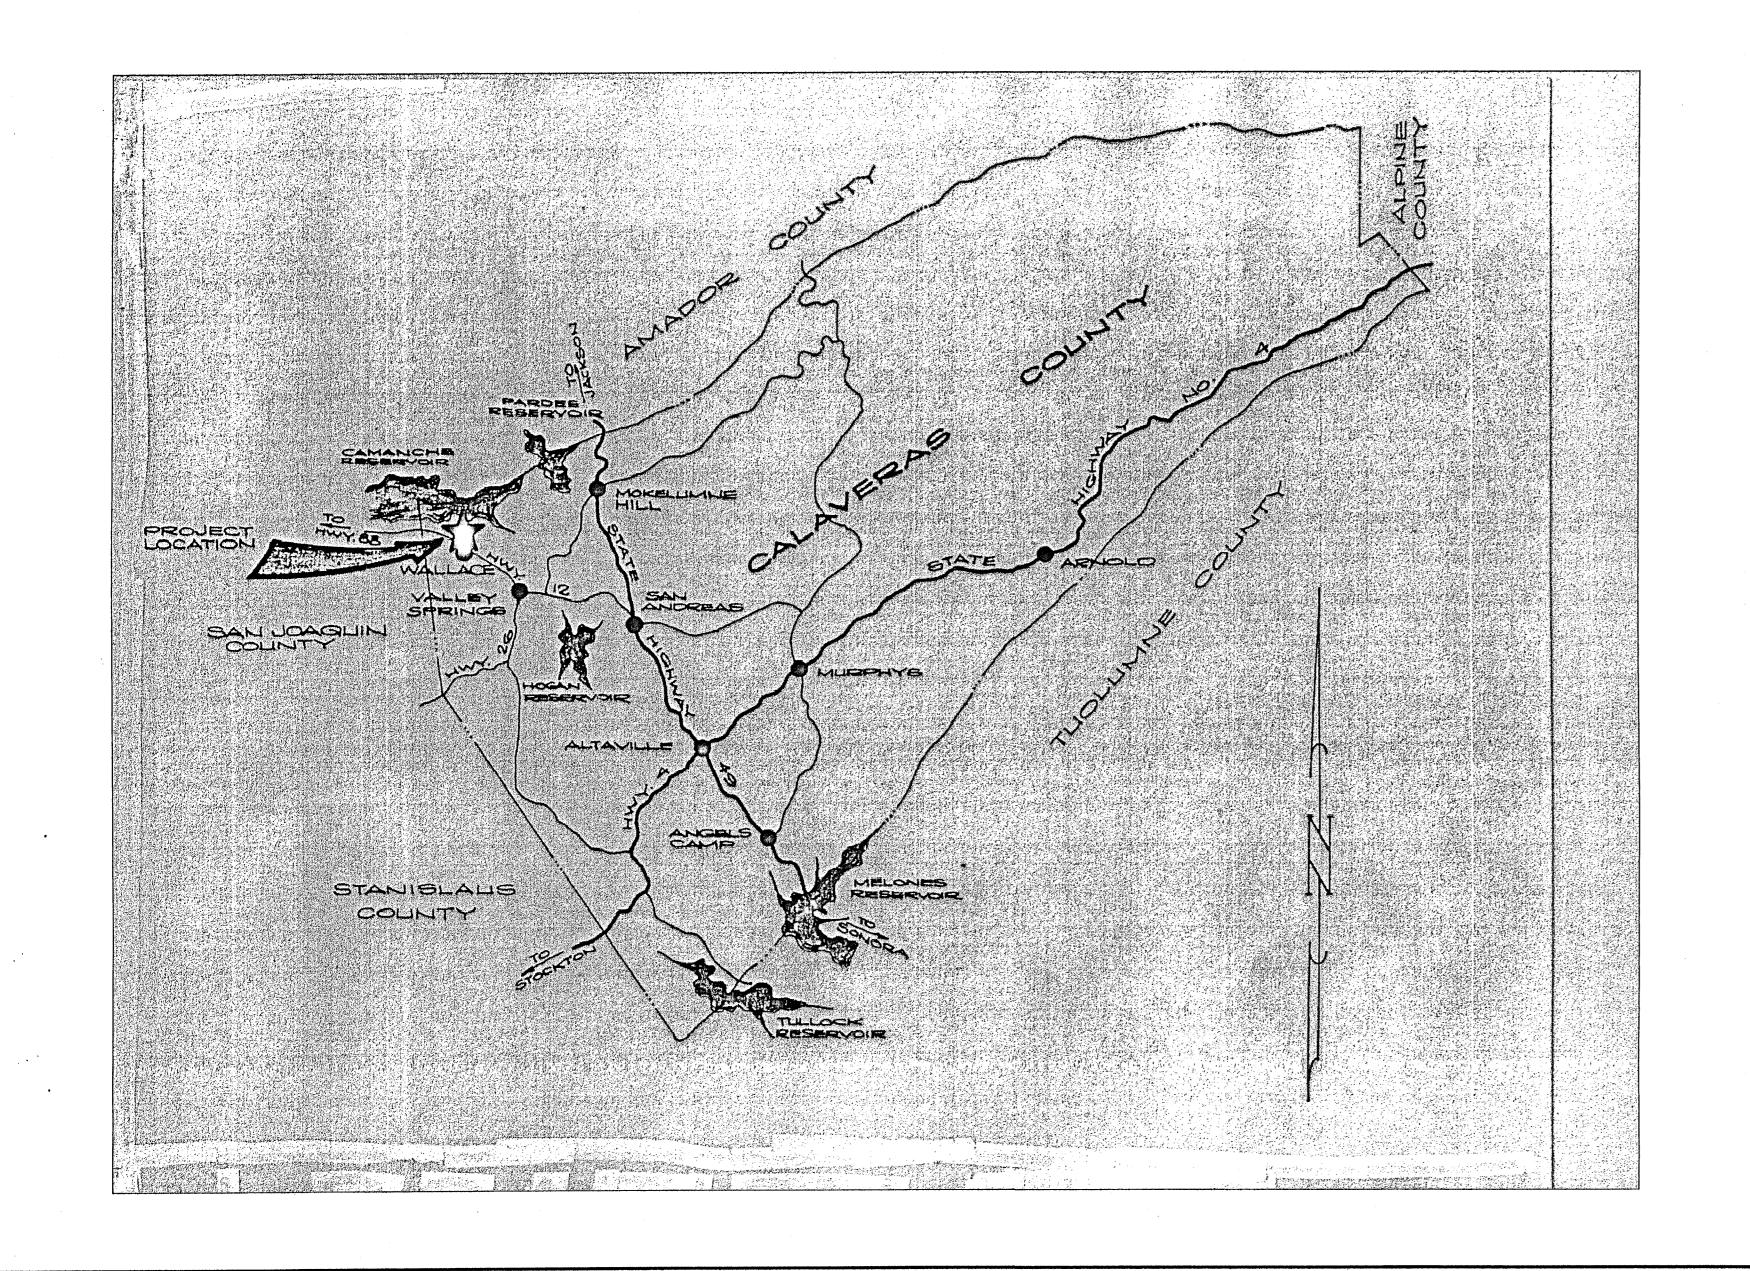

OWNER / DEVELOPER	INDEX TO PLAN	A A A A
JOHN BOYD STERLING BUILDERS 39 CALIFORNIA AVE. SUITE 205A PLEASANTON, CA. 64566 PHONE: (925) 846-9433 FAX: (925) 846-9434	SHEET NO. CONTENTS  1 TITLE SHEET, SHEET INDEX, VICINITY MAP  2 SEWER IMPROVEMENT PLAN	/EMENT PLANDGE UNIT 1B ION OF CE LAKE EST, AKE ESTATES, UNIT CALIFORNIA
ENGINEER	3 WATER IMPROVEMENT PLAN	
GENE WEATHERBY WEATHERBY-REYNOLDS-FRITSON ENGINEERING AND DESIGN 206 PEEK STREET JACKSON, CA. 95642 PHONE: (209) 223-0381 FAX: (209) 223-0716	5 ELECTRICAL PLANS (P.G. & E.) 6 WATER AND SEWER DETAILS	IMPRO  LAKERI  A PORT  WALLACE  WALLACE  WALLACE  WALLACE
COMMUNITY SERVICE DISTRICT	ENGINEER OF WORK:	ENGINEERING AND DESIGN
WALLACE COMMUNITY SERVICE DISTRICT P.O. BOX 398 WALLACE, CA. 95254  DISTRICT ENGINEER: GARY GHIO WEBER, GHIO AND ASSOCIATES P.O. BOX 251 SAN ANDREAS, CA. 95249 PHONE: (209) 754-1824 FAX: (209) 754-1092	WEXTHERBY-REYNOLDS-FRITSON EMGINEERING AND DESIGN EUGENE WEATHERBY R.C.E. 47760  LIC. EXP. 3-31-07  GARY GHO DISTRICT ENGINEER  DATE  DATE  2/5/07  DATE  C/VIL  OF CALIFORM  A-73.07  DATE  DATE  CAMPORA PROPANE SERVICE	(209)-223-0381 [Voice] (209)-223-0716 [Fax] (206)-223-0716 [Fax] (206)-2
		FILE NO. D-5598  DRAWN BY JL
	APPROVALS	DATE 05-2006  SCALE AS NOTED
	THIS DRAWING IS NOT FINAL AND IS NOT TO BE USED FOR CONSTRUCTION UNTIL STAMPED AND WET-SIGNED BY THE PROJECT ENGINEER.  Construction contractor agrees that in accordance with generally accepted construction practices, construction contractor will be required to assume sole and complete responsibility for job site conditions during the course of construction of the project, including safety of all persons and property; that this requirement shall be made to apply continuously and not be limited to normal working hours, and construction contractor further agrees to defend, indemnify and hold design professional harmless from any and all liability, real or alleged, in connection with the performance of work on this project, excepting liability arising from the sole negligence of design professional.	SHEET  1 OF 6 SHEETS

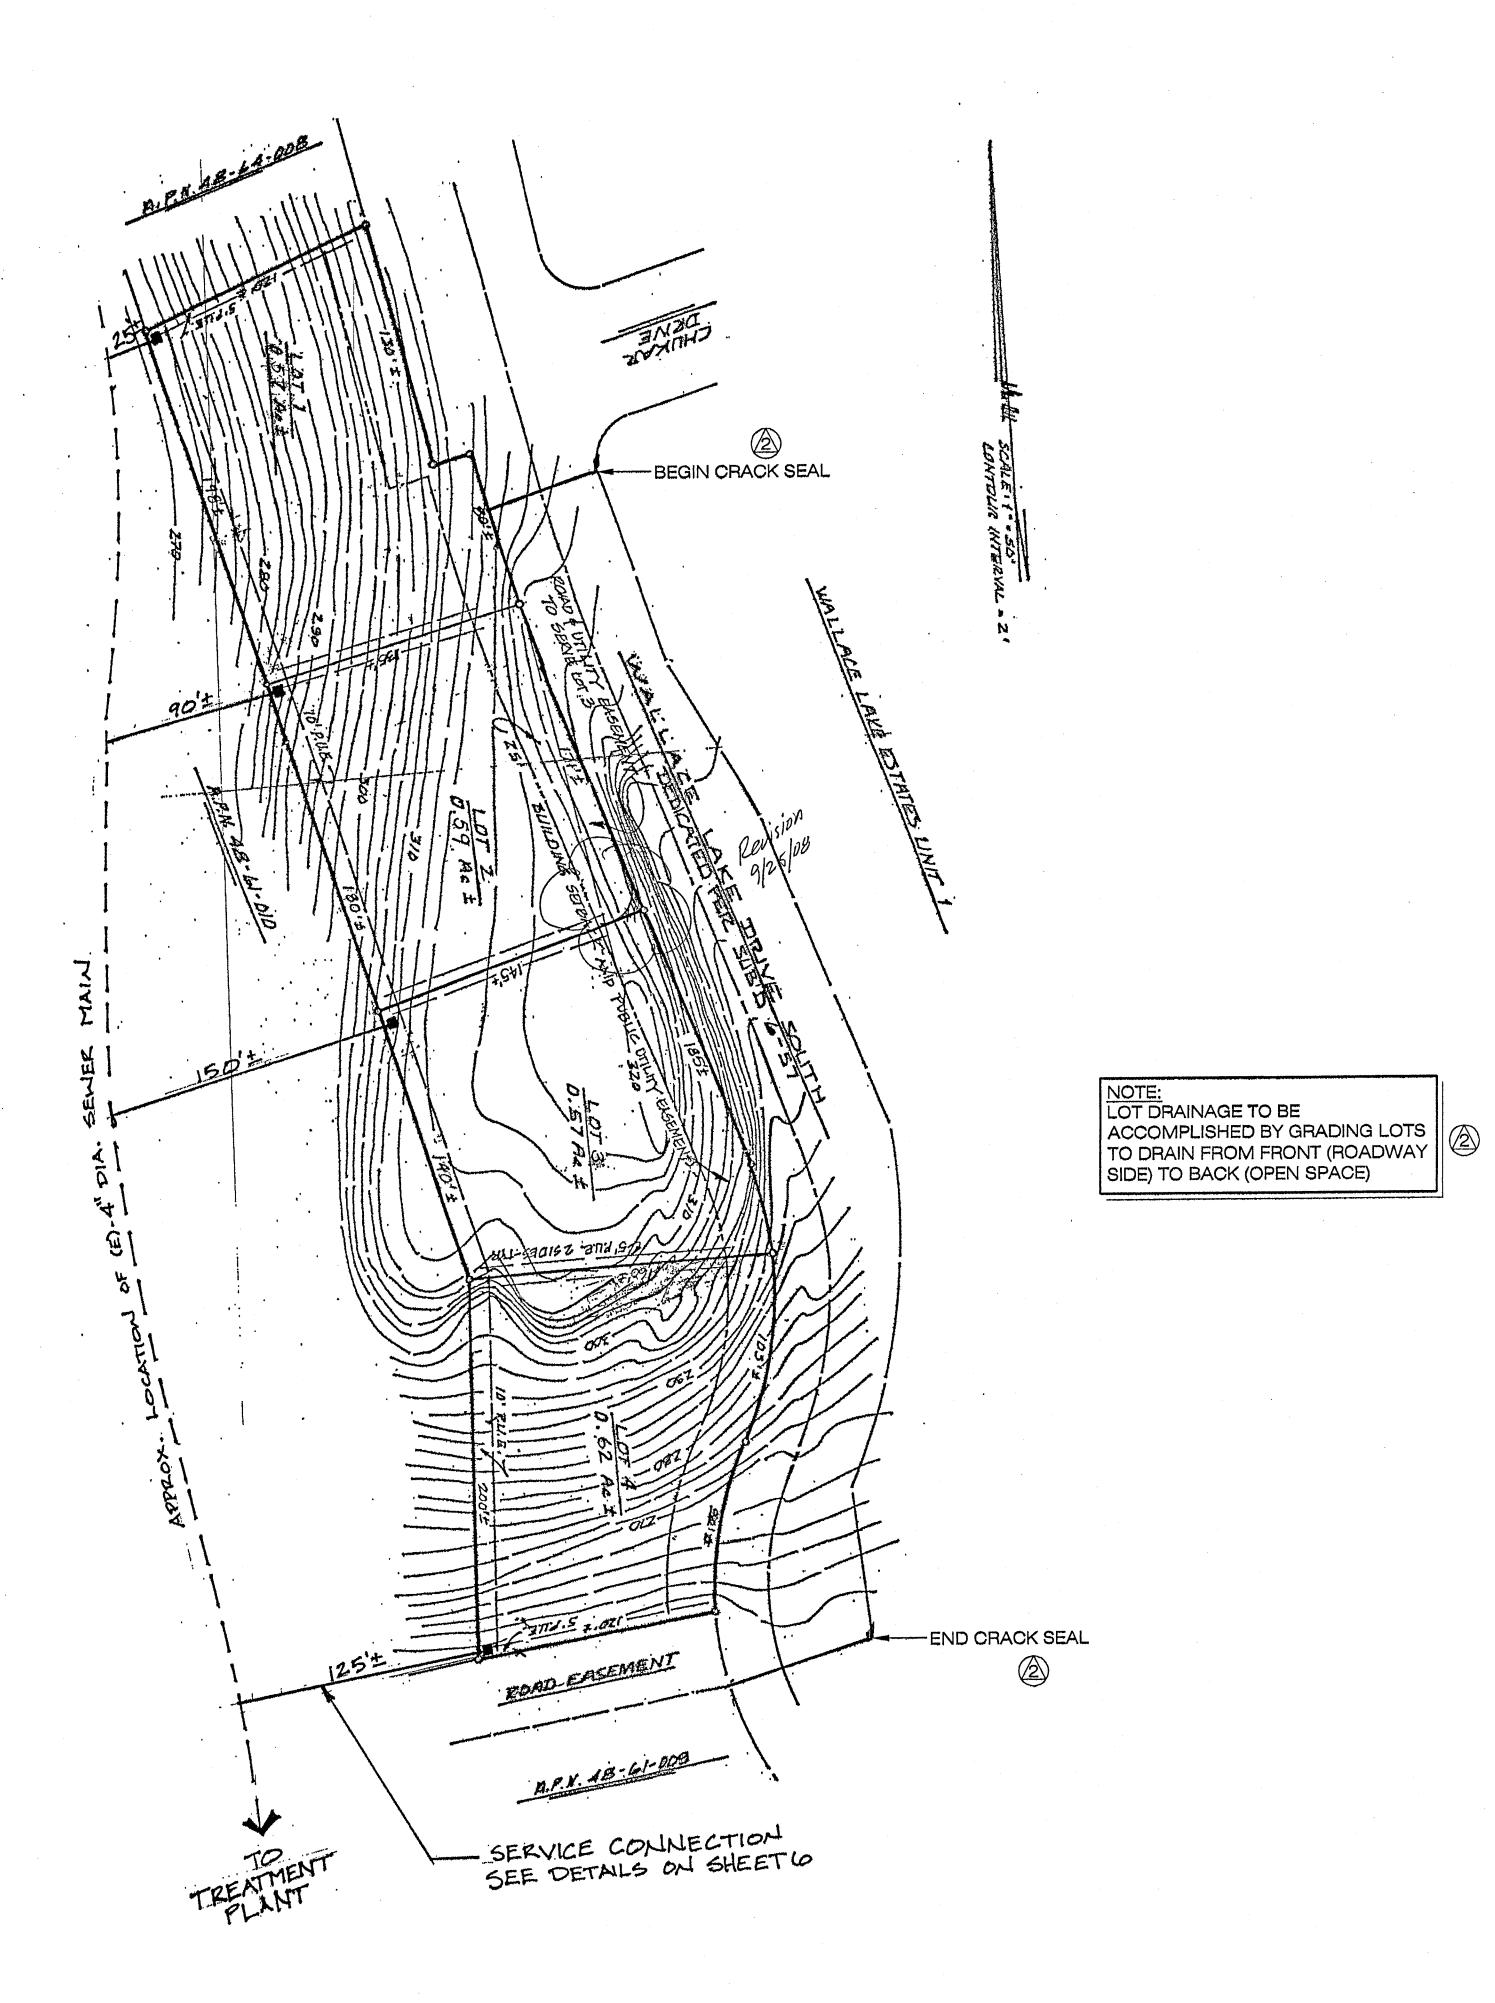

WALLACE COMMUNITY SERVICES DISTRICT **GENERAL NOTES FOR IMPROVEMENT PLANS** 

The following "General Notes: represent the minimum which are required on Subdivision Improvement Plans. Additional notes may be required by the District or added by the Engineer of Work to more fully explain the intent of the Drawings and the work contemplated.

### **GENERAL NOTES**

### **DEFINITIONS**

Contractor - the contractor or sub-contractor engaged in the performance of the work depicted on these plans.

District - The Wallace Community Services District.

District Engineer - Weber-Ghio Associates

Engineer of Work - The consulting civil engineer whose signature these plans

### CONTRACTOR QUALIFICATIONS

- 1) All contractors and sub-contractors performing work within the public right-of-way shall be licensed in the State of California under the provisions of Chapter 9, Division 3, of the Business and Professions Code, and shall be bondable for an amount equal to or greater than the amount of the work they are to perform.
- Contractors and sub-contractors shall be skilled and regularly engaged in the general class of work they are to perform.

### **DISCREPANCIES**

1) The contractor shall notify the Engineer of Work immediately regarding any discrepancies or ambiguities, which may exist in the plans or specifications.

### IMPROVEMENT STANDARD

All improvements within the public right-of-way shall be constructed in accordance with the 2004 Wallace Community Services District Improvements Standards.

- 1) The Contractor shall be responsible for obtaining all permits and licenses for the construction and completion of the work.
- 2) The Contractor shall apply for an encroachment permit from the Wallace Community Services District for all work within the right-of-way.

### INSPECTION BY DISTRICT

- 1) All work is subject to observation and inspection by the Wallace Community Services District.
- The Contractor shall notify the Wallace Community Services, PG&E, Telephone, Cable TV, Campora Gas, and other appropriate agencies a minimum of forty-eight (48) hours in advance of commencing any work with their right-of-way.
- Notify the District Engineer at (209) 754-1824, a minimum of forty-eight (48) hours in advance of commencing any work within the District right-of-way.
- The Contractor shall perform testing of all compacted areas in accordance with Wallace Community Services District Improvement Standards.

### SAFETY

- 1) The Contractor shall exercise caution and shall carefully preserve all benchmarks, survey monuments, etc., and shall bear all costs for the replacement of same if damaged or destroyed.
- The Contractor shall be responsible for public safety and shall provide all barricades, signs, lights, and flagmen necessary or required.
- The Contractor shall preserve the integrity and location of all work within the public right-of-way, and provide all necessary construction traffic control.

### **EXISTING UTILITIES**

- 1) Prior to commencing work, the Contractor shall have each utility company locate, in the field, their main and service lines. The Contractor shall notify the members of Underground Service Alert (USA) forty-eight (48) hours in advance of performing any underground excavation by calling the toll-free number (800) 227-2600. The Contractor shall record the USA order number and furnish the order number to the Engineer of Work and District Engineer prior to any excavation.
- It shall be the Contractor's responsibility to expose all existing underground utilities related to the project, including, but not limited to sewer, storm drain, water irrigation, gas, electrical, street lighting, etc., and shall notify the District Engineer forty-eight (48) hours in advance of exposing the utilities. If the location and/or elevation differs from that shown on the plans, the District Engineer shall be so notified and provisions to accommodate new location or elevation shall be made prior to proceeding with construction.

### RESPONSIBILITY FOR WORK

- 1) The Contractor shall be responsible for protecting existing improvements from damage. The cost of repairing or replacing existing improvements damaged shall be borne by the Contractor.
- 2) Whenever existing facilities are damaged, broken and/or cut in the performance of the work, said facilities shall be replaced at the Contractor's expense. Repair of facilities shall conform to current District Standards and shall be subject to the observation and approval of the District Engineer.

### **EXCAVATIONS**

1) The Contractor's attention is called to Title 8 California Administrative Code, Section 1540(A)(1) of the construction safety orders issued by the Occupational Safety and Health Standards Board pursuant to the California Occupations Safety and Health Act of 1973 which states:

"Prior to opening and excavation, effort shall be made to determine whether underground installations; i.e. sewer, water, fuel, electric lines, etc., will be encountered and if so, where such underground installations are located. When the excavation approaches the approximate location of such installation, the exact location shall be determined by careful probing and or hand digging; and when it is uncovered, adequate protection shall be provided for the existing installation. All known owners of underground facilities in the area concerned shall be advised of the proposed work at least forty-eight (48) hours prior to the start of actual excavations."

- Excavations of 5 feet or more in depth require an excavation permit from the State of California Department of Industrial Safety. The Contractor shall comply with Section 5-1.02a of the Cal Trans Standards and, Chapter 9 of the State of California Labor Code.
- The Contractor shall provide all shoring, bracing, sloping, or other provisions necessary to protect workmen for all areas to be excavated to a depth of 5 feet or more.

### RECORD DRAWINGS

The Contractor shall maintain a neatly marked set of full-sized record drawings showing the final location and layout of all improvements installed. The As-Built drawings shall include, but not be limited to grading; underground facilities; curb, gutter, and sidewalk; mechanical; street lighting; electrical and instrumentation equipment. The As-Built drawings shall reflect all changes in the work which deviate from the information shown on the drawings. Where necessary to depict the changed conditions, the Contractor shall prepare supplemental drawings. As-Built drawings shall be submitted to the district engineer upon completion of work.

- Earthwork shall be performed in accordance with the Standards of the Wallace Community Services District.
- All fill areas shall be tested as required by the Wallace Community Services District.

### SANITARY SEWERS AND STORM DRAINS

- 1) All sanitary sewer and storm drain materials and construction shall conform to the Wallace Community Services District Improvement Standards.
- 2) All pipe shall be laid to conform to the lines and grades prescribed on the drawings using a laser leveling device.
- 3) All gravity piping will be subject to pressure testing in accordance with the Wallace Community Services District Improvements Standards.
- 4) The minimum cover on sanitary sewer and storm drain lines is 36".

### WATER SYSTEM

- All water system materials and construction shall conform to the Wallace Community Services District Improvements Standards.
- 2) All pipe shall be installed to conform to the lines and grades prescribed on the drawings.
- The water system shall be subject to pressure testing and bacteriological testing in accordance with the Wallace Community Services District Improvements Standards.

### ELECTRICAL

Prior to final acceptance of the improvements described in these drawings and specifications, the Contractor shall coordinate the energizing of all gas, electrical, and street lighting systems with the District, PG&E, and Campora Gas.

- All underground utilities shall be installed, tested, in operating condition prior to installation of curb, gutter, sidewalk, and paving.
- All maintenance holes, lamp holes, cleanouts, water valve boxes, monument boxes, etc. shall be installed and adjusted to grade after street paving has been completed.
- After completion of all work within paved street sections the street shall After completion of all the limits shown.

### **CLEAN-UP**

- 1) The Contractor shall be responsible for controlling dust from his operations at all times. Dust control shall conform to Cal Trans
- 2) Prior to final acceptance by the District, the Contractor shall leave the site, including lots and improvements within the right-of-way, in a neat, clean condition free, from construction materials, debris, trash, etc.

### **END OF GENERAL NOTES**


### **APPROVALS**

THIS DRAWING IS NOT FINAL AND IS NOT TO BE USED FOR CONSTRUCTION INTIL STAMPED AND WET-SIGNED BY THE PROJECT ENGINEER. Construction contractor agrees that in accordance with generally accepted construction practices, construction contractor will be required to assume sole and complete responsibility for job site conditions during the course of construction of the project, including safety of all persons and property; that this requirement shall be made to apply continuously and not be limited to normal working hours, and construction contractor further agrees to defend, indemnify and hold design professional harmless from any and all liability, real or alleged, in connection with the performance of work on this project, excepting liability arising from the sole negligence of design professional.

REVISIONS

PLANS



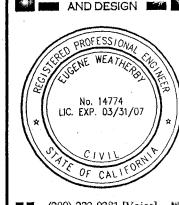

(209)-223-0381 [Voice] (209)-223-0716 [Fax] 206 Peek Street Jackson, CA. 95642 http://www.wrfed.com


THESE DRAWINGS AND THE CONCEPT EMBODIED THEREIN ARE THE ORIGINAL UNPUBLISHED WORK OF WAF NOT BE USED OR DUPLICATED WITHOU THE WRITTEN AGREEMENT OF TERRY WEATHERBY, GRANT REYNOLDS, OR

DRAWINGS SEWER LINE **IMPROVEMENT** PLAN AND NOTES


FILE NO. D-5598 DRAWN BY DATE

05-2006 SCALE AS NOTED SHEET

OF 6 SHEETS

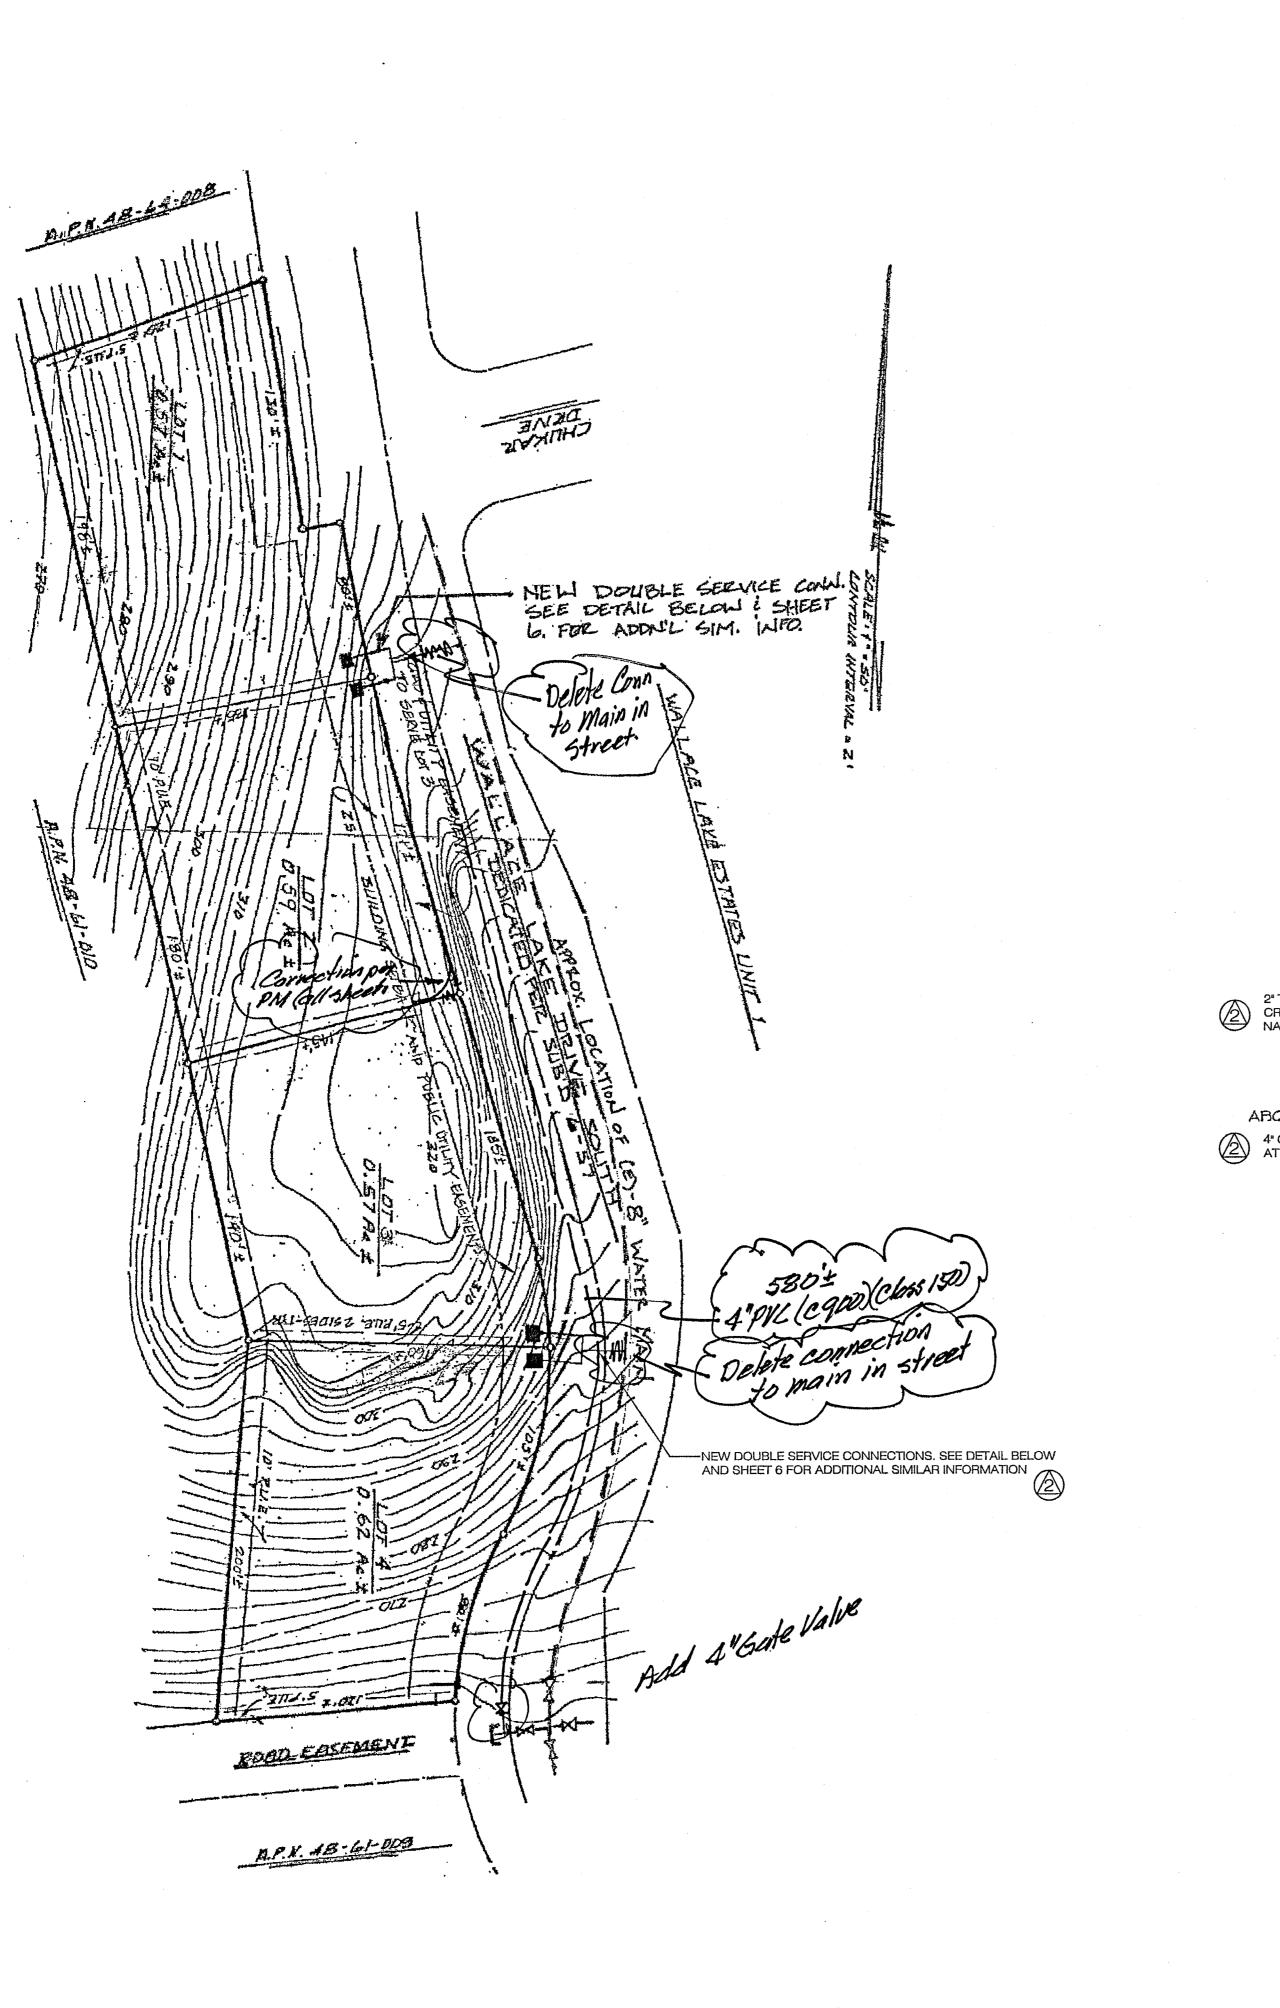

DRAINAGE REPAIR EXLIBIT
LAKERIDGE SUBDIVISION UNIT 1B

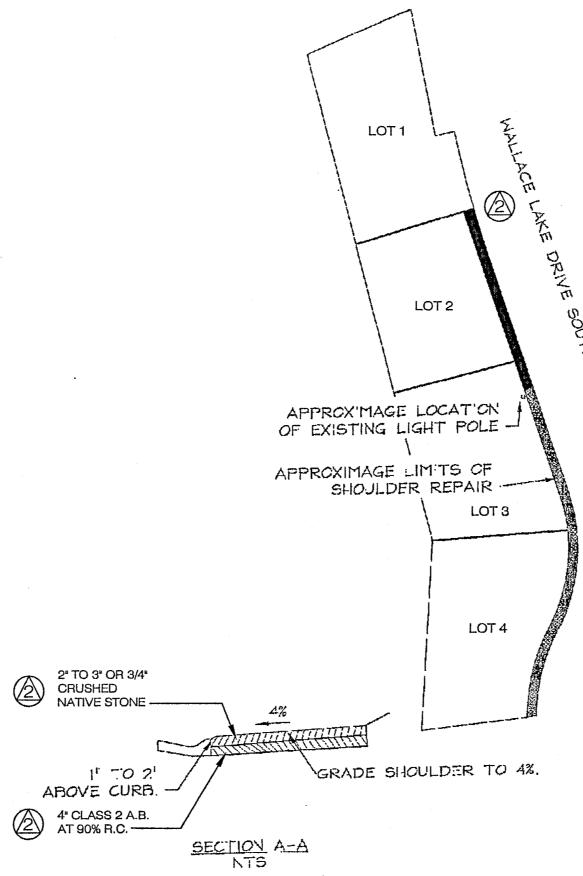

WATER MAIN

WYE- FORD Y44-243

WARIES'

WARIES'

R/W

PLAN

DOUBLE SERVICE

NOTES:

1. TRENCHES UNDER PAVING SHALL BE BACKFILLED WITH CONTROLLED DENSITY BACKFILL. SEE DETAIL SS-2 AND W-4 ON SHEET 6.

2. THE DISTRICT EMERGENCY CONTRACTOR OR OTHER CONTRACTOR APPROVED BY THE DISTRICT SHALL MAKE ALL CONNECTIONS INTO EXISTING DISTRIBUTION OR TRANSMISSION LINE AT THE DEVELOPERS EXPENSE.

3. UNDER NO CIRCUMSTANCES SHALL ANYONE OTHER THAN A REPRESENTATIVE OF THE DISTRICT OPEN OR CLOSE ANY VALVE IN A DISTRICT OPERATED WATER SYSTEM.

LEGEND

---- (E)-EXISTING WATER LINE

NEW WATER LINE CLASS 150 C900 PVC

EXISTING HYDRANT

EXISTING SERVICE

EXISTING SERVICE

NEW DOUBLE SERVICE CONNECTION.
SEE SERVICE CONNECTION DETAIL ON SHEET 6.

# APPROVALS

THIS DRAWING IS NOT FINAL AND IS NOT TO BE USED FOR CONSTRUCTION UNTIL STAMPED AND WET-SIGNED BY THE PROJECT ENGINEER.

Construction contractor agrees that in accordance with generally accepted construction practices, construction contractor will be required to assume sole and complete responsibility for job site conditions during the course.

Construction contractor agrees that in accordance with generally accepted construction practices, construction contractor will be required to assume sole and complete responsibility for job site conditions during the course of construction of the project, including safety of all persons and property; that this requirement shall be made to apply continuously and not be limited to normal working hours, and construction contractor further agrees to defend, indemnify and hold design professional harmless from any and all liability, real or alleged, in connection with the performance of work on this project, excepting liability arising from the sole negligence of design professional.

No. 14774 LIC. EXP. 03/31/07 (209)-223-0381 [Voice] (209)-223-0716 [Fax] 206 Peek Street Jackson, CA. 95642 http://www.wrfed.com EMBODIED THEREIN ARE THE ORIGINA UNPUBLISHED WORK OF WRF ENGINEERING AND DESIGN AND SHA NOT BE USED OR DUPLICATED WITHO THE WRITTEN AGREEMENT OF TERRY WEATHERBY, GRANT REYNOLDS, OR KEVIN FRITSON DRAWINGS **=** WATER LINE IMPROVEMENT PLAN AND NOTES FILE NO. D-5598

OVALS


DRAWN BY JL


DATE 05-2006

SCALE AS NOTED

SHEET

3 OF 6 SHEETS

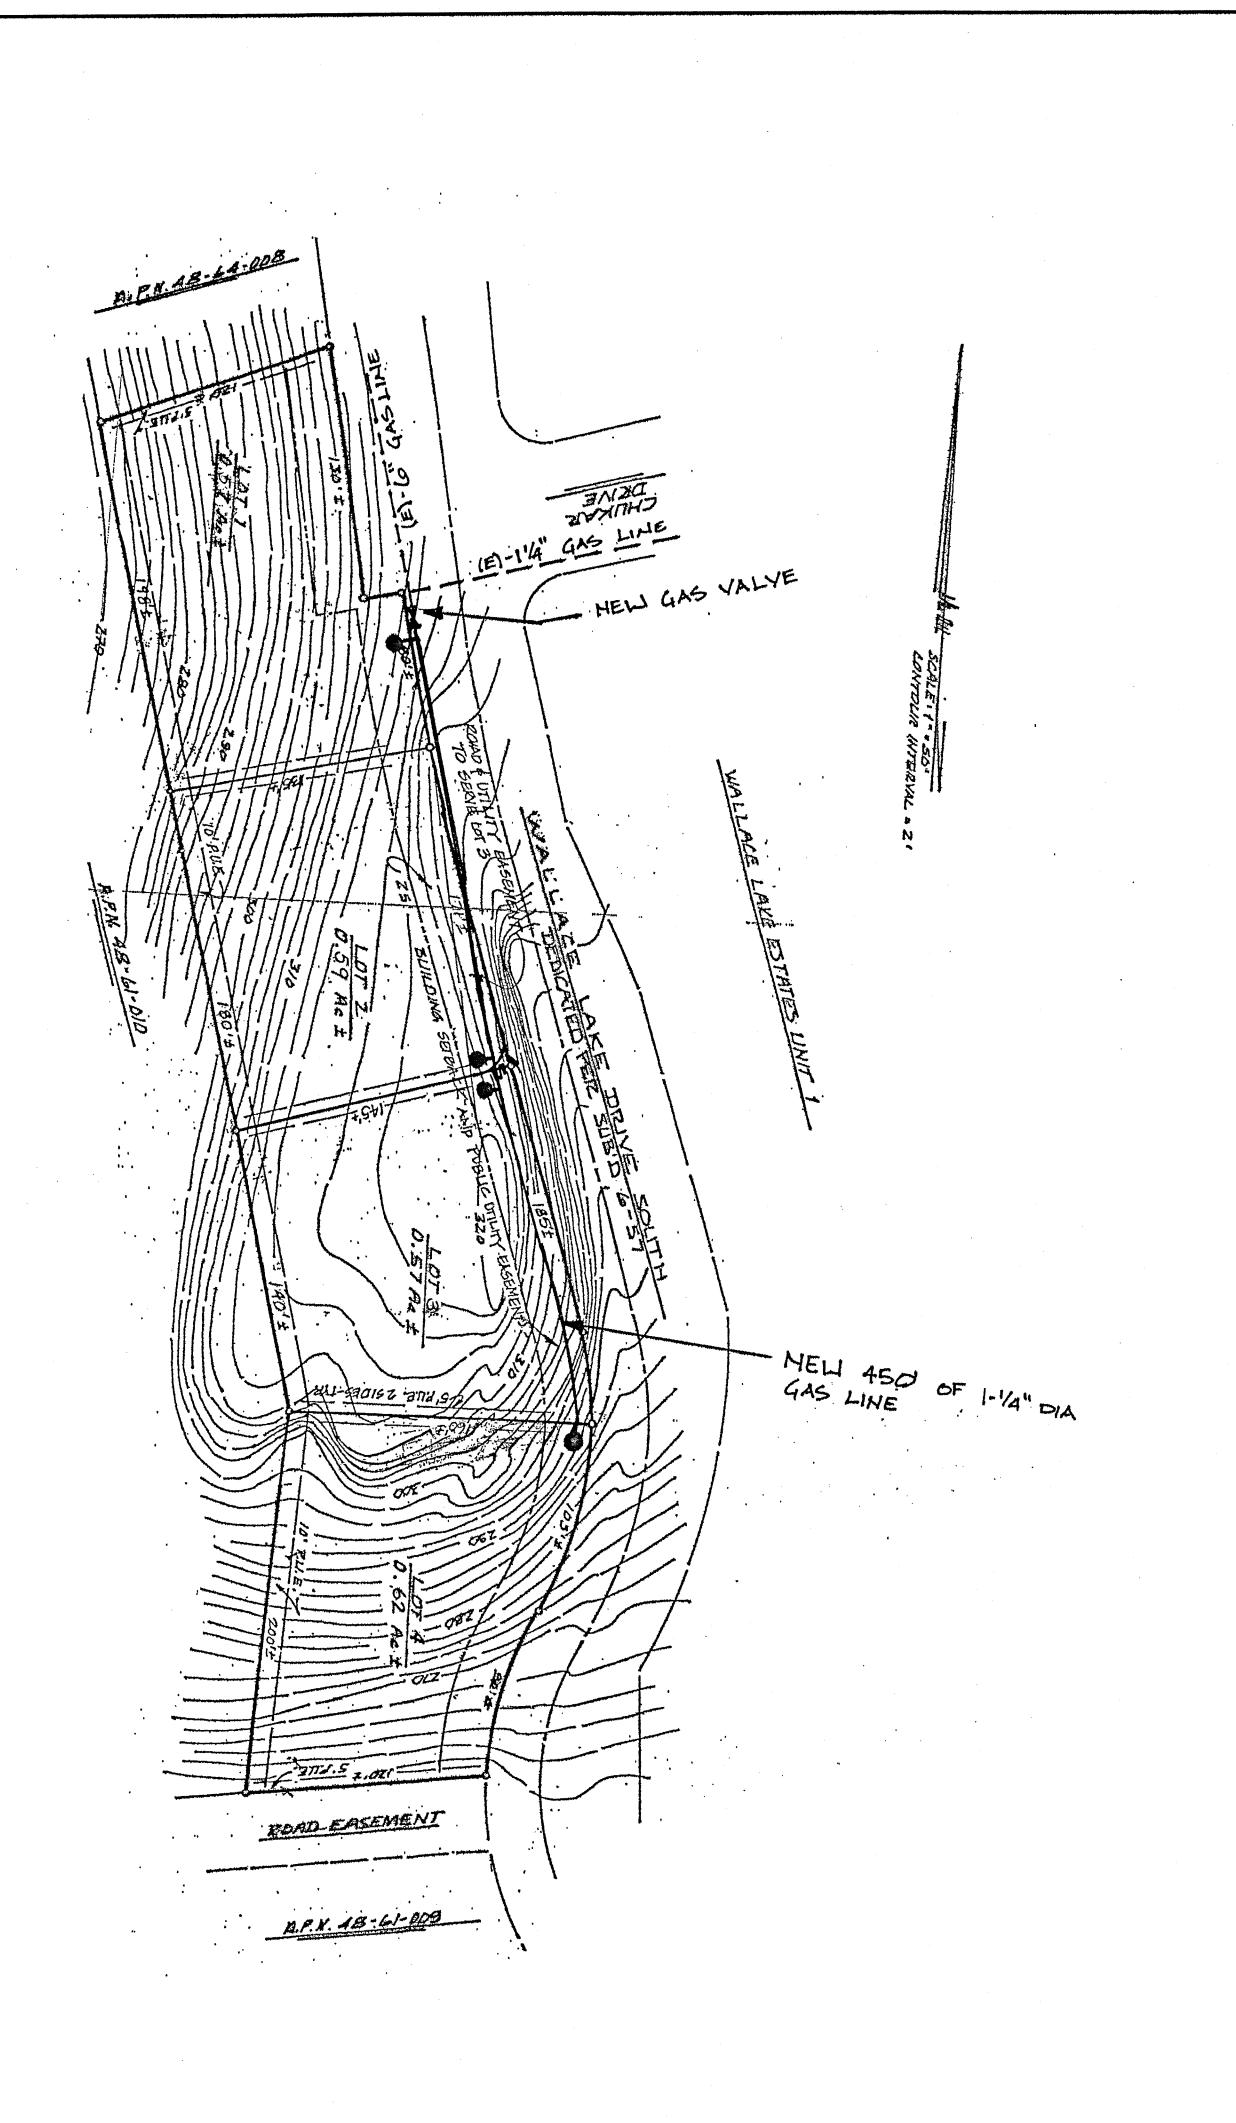

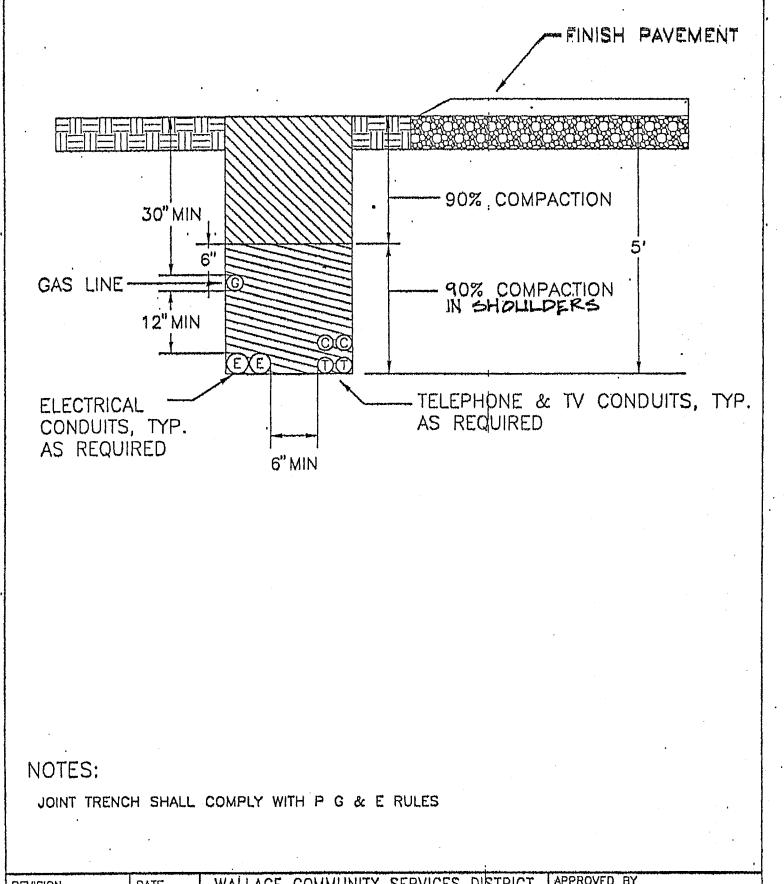

REVISION	DATE	WALLACE COMMUNITY SERVICES DISTRICT CALAYERAS COUNTY	APPROVED BY
		JOINT UTILITY TRENCH	WALLACE COMMUNITY SERVICES DISTRICT PRESIDENT NOVEMBER 2001
		IN EASEMENT	IMPROVEMENT STANDARD NO. U-1

PART 1 - GENERAL

1.01 STANDARDS

A. Gas service shall conmform to paragraphs 1-4, 6-10, & 12 of Section 2, Gas, of "Electric & Gas Service Reaulremtns", by Pacific Gas & Electric Company, 1995.

### PART 2 - MATERIALS

### 2.01 POLYETHYLENE PLASTIC PIPE

- A. Polyethylene plastic pipe shall meet the requirement of ASTM D2513, "Standard Specification for Thermoplastic Gas Pressure Pipe, Tubing and Fittings."
- B. Polyethylene plastic pipe shall have a maximum SDR (ratio of pipe diameter to wall thickness) equal to 11.5, and standard pipe lengths equal to 40 feet. Working pressure shall be 100 psig.

### 2.02 SOCKET FITTINGS

A. Socket fittings shall conform to ASTM D2683.

2.03 BUTT-FUSION FITTINGS

A. Butt-fusion fittings shall conform to ASTM D2513, molded.

### 04 RISER

A. Riser shall consist of a manufacturer's standard transition fitting, transition from plastic to 7 mil to 12 mil thick epoxy-coated steel pipe and swaged gas-tight with 0-ring seals and metal insert. Provide manufacturer's standard protection sleeve and riser supports as required.

### 1 2.05 GAS PRESSURE REDUCING VALVES

A. Gas pressure reducing valves shall be sized for load and inlet conditions and shall be provided with low pressure cut-off and internal over pressure relief. Where meter is inside buildings, pipe relief discharge to outside of building. Gas pressure reducing valves shall conform to P.G. & E requirements and shall be Rockwell; Fischer; or equal.

### 2,06 GAS METER

A. Gas meter shall be a pedestal mounted, diaphragm, bellows, or turbine style, as required, sized for load and inlet conditions. Gas meter shall have aluminum or enamel coated steel case with resettable counter. Furnish combined register totalizer with escape hole in housing, and means for sealing against tampering. Gas meter shall conform to P.G. & E requirements and shall be Rockwell; Fischer, or equal.

### 2.07 VALVE BOXES

- A. Valve boxes shall be manufactured of a high density reinforced concrete with a minimum compressive strength of 4000 PSI. Boxes shall have a belled top or flared shoulders to prevent settling and an integral cast Iron seat of the rattle proof design and a cast Iron lid. The box and lid shall be H-20 rated.
- B. Valve box lids shall be manufactured of cast iron with machined seating surfaces. Lids shall be provided with cast-in markings indicating "Gas". Lids with welded markings will not be acceptable.
- C. Extensions shall be as manufactured for the box or 8" Class 100 PVC pipe. Grade rings for adjusting the box shall be as manufactured for the box.
- D. The valve box shall be Christy G5; Brooks; or equal.

### 2.08 LOCATOR WIRE

A. Locator Wire shall be #12 UF conforming to NEMA standards and NEC Article 339 for direct burial. Splicing of wire shall be made with a water proof epoxy splice kit.

### 2.09 MISCELLANEOUS MATERIALS

A. Any incidental material or equipment not mentioned in these specifications or shown on the plans which may be necessary for completion and successful operation of the gas service system, or required by the Utility Company, shall be furnished and installed as though shown or provided for.

### CONSTRUCTION NOTES

PART 2 - MATERIALS

### 2.01 PVC SEWER PIPE

- A. Sewer pipe used for gray water from septic tank systems shall be Schedule 40 polyvinyl chloride pipe for solvent weld applications.
- B. Fittings shall be schedule 40 PVC.
- C. Solvent weld cleaner and glue shall be as approved by the pipe manufacturer.

### PART 3 - CONSTRUCTION


## 3.01 MAIN LINES

A. Grey water sewer main lines shall be installed on a uniform slope without deviation from the grade line. Lines shall be sloped to achieve a minimum velocity of 2 feet per second

### 3.02 LATERALS

A. Laterals between septic tank and the main line shall be installed at a uniform slope not less than 2%.

Trenches under paving shall be backfilled with controlled density backfill, see Detail Sheet 4 of 6.

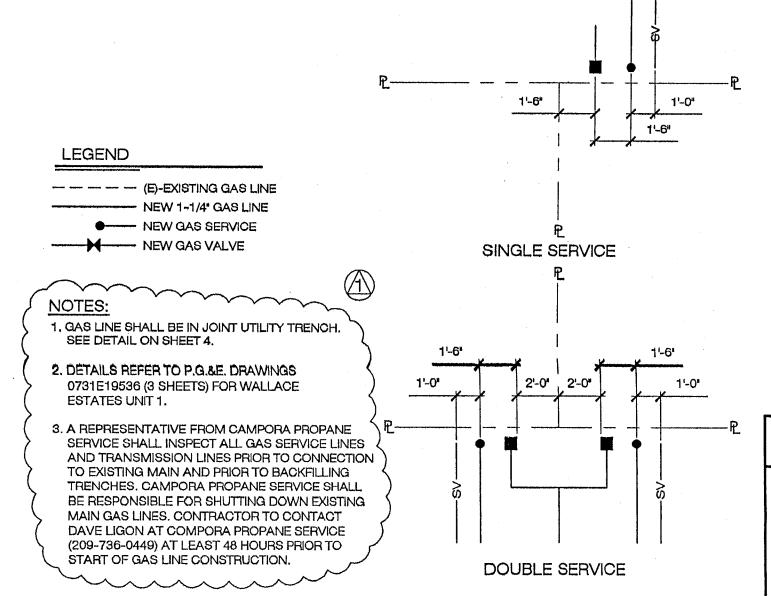

## APPROVALS

THIS DRAWING IS NOT FINAL AND IS NOT TO BE USED FOR CONSTRUCTION UNTIL STAMPED AND WET-SIGNED BY THE PROJECT ENGINEER.

UNTIL STAMPED AND WET-SIGNED BY THE PROJECT ENGINEER.

Construction contractor agrees that in accordance with generally accepted construction practices, construction contractor will be required to assume sole and complete responsibility for job site conditions during the course of construction of the project, including safety of all persons and property; that this requirement shall be made to apply continuously and not be limited to normal working hours, and construction contractor further agrees to defend, indemnify and hold design professional harmless from any and all liability, real or alleged, in connection with the performance of work on this project, excepting liability arising from the sole negligence of design professional.

REVISIONS

ING ADDRESS:
NG BUILDERS
30YD
IFORNIA AVE. SUITE 205A
ANTON, CA. 94566

MAILING ADE STERLING BUILDER JOHN BOYD 39 CALIFORNIA AVE PLEASANTON, CA. (925) 846-9133

T PLANS FOR:
IT 1B


E ESTATES
ES, UNIT 1, TRACT 434

KERIDGE UNIT 1E ORTION OF ALLACE LAKE ESTATES, UNITACE CALIFORNIA

LAKERID
A PORTIC
WALLACE LA
WALLACE LA
WALLACE LA

WEATHERBY-REYNOLDS-FRITSON

ENGINEERING
AND DESIGN

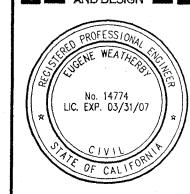

(209)-223-0381 [Voice] (209)-223-0716 [Fax] 206 Peek Street Jackson, CA. 95642 http://www.wrfed.com

THESE DRAWINGS AND THE CONCEPTS EMBODIED THEREIN ARE THE ORIGINAL UNPUBLISHED WORK OF WAFE ENGINEERING AND DESIGN AND SHALL NOT BE USED OR DUPLICATED WITHOU THE WRITTEN AGREEMENT OF TERRY WEATHERBY, GRANT REYNOLDS, OR KEVIN FRITSON

FILE NO. D-5598


DRAWN BY JL


DATE 05-2006

SCALE AS NOTED

SHEET


4 OF 6 SHEETS

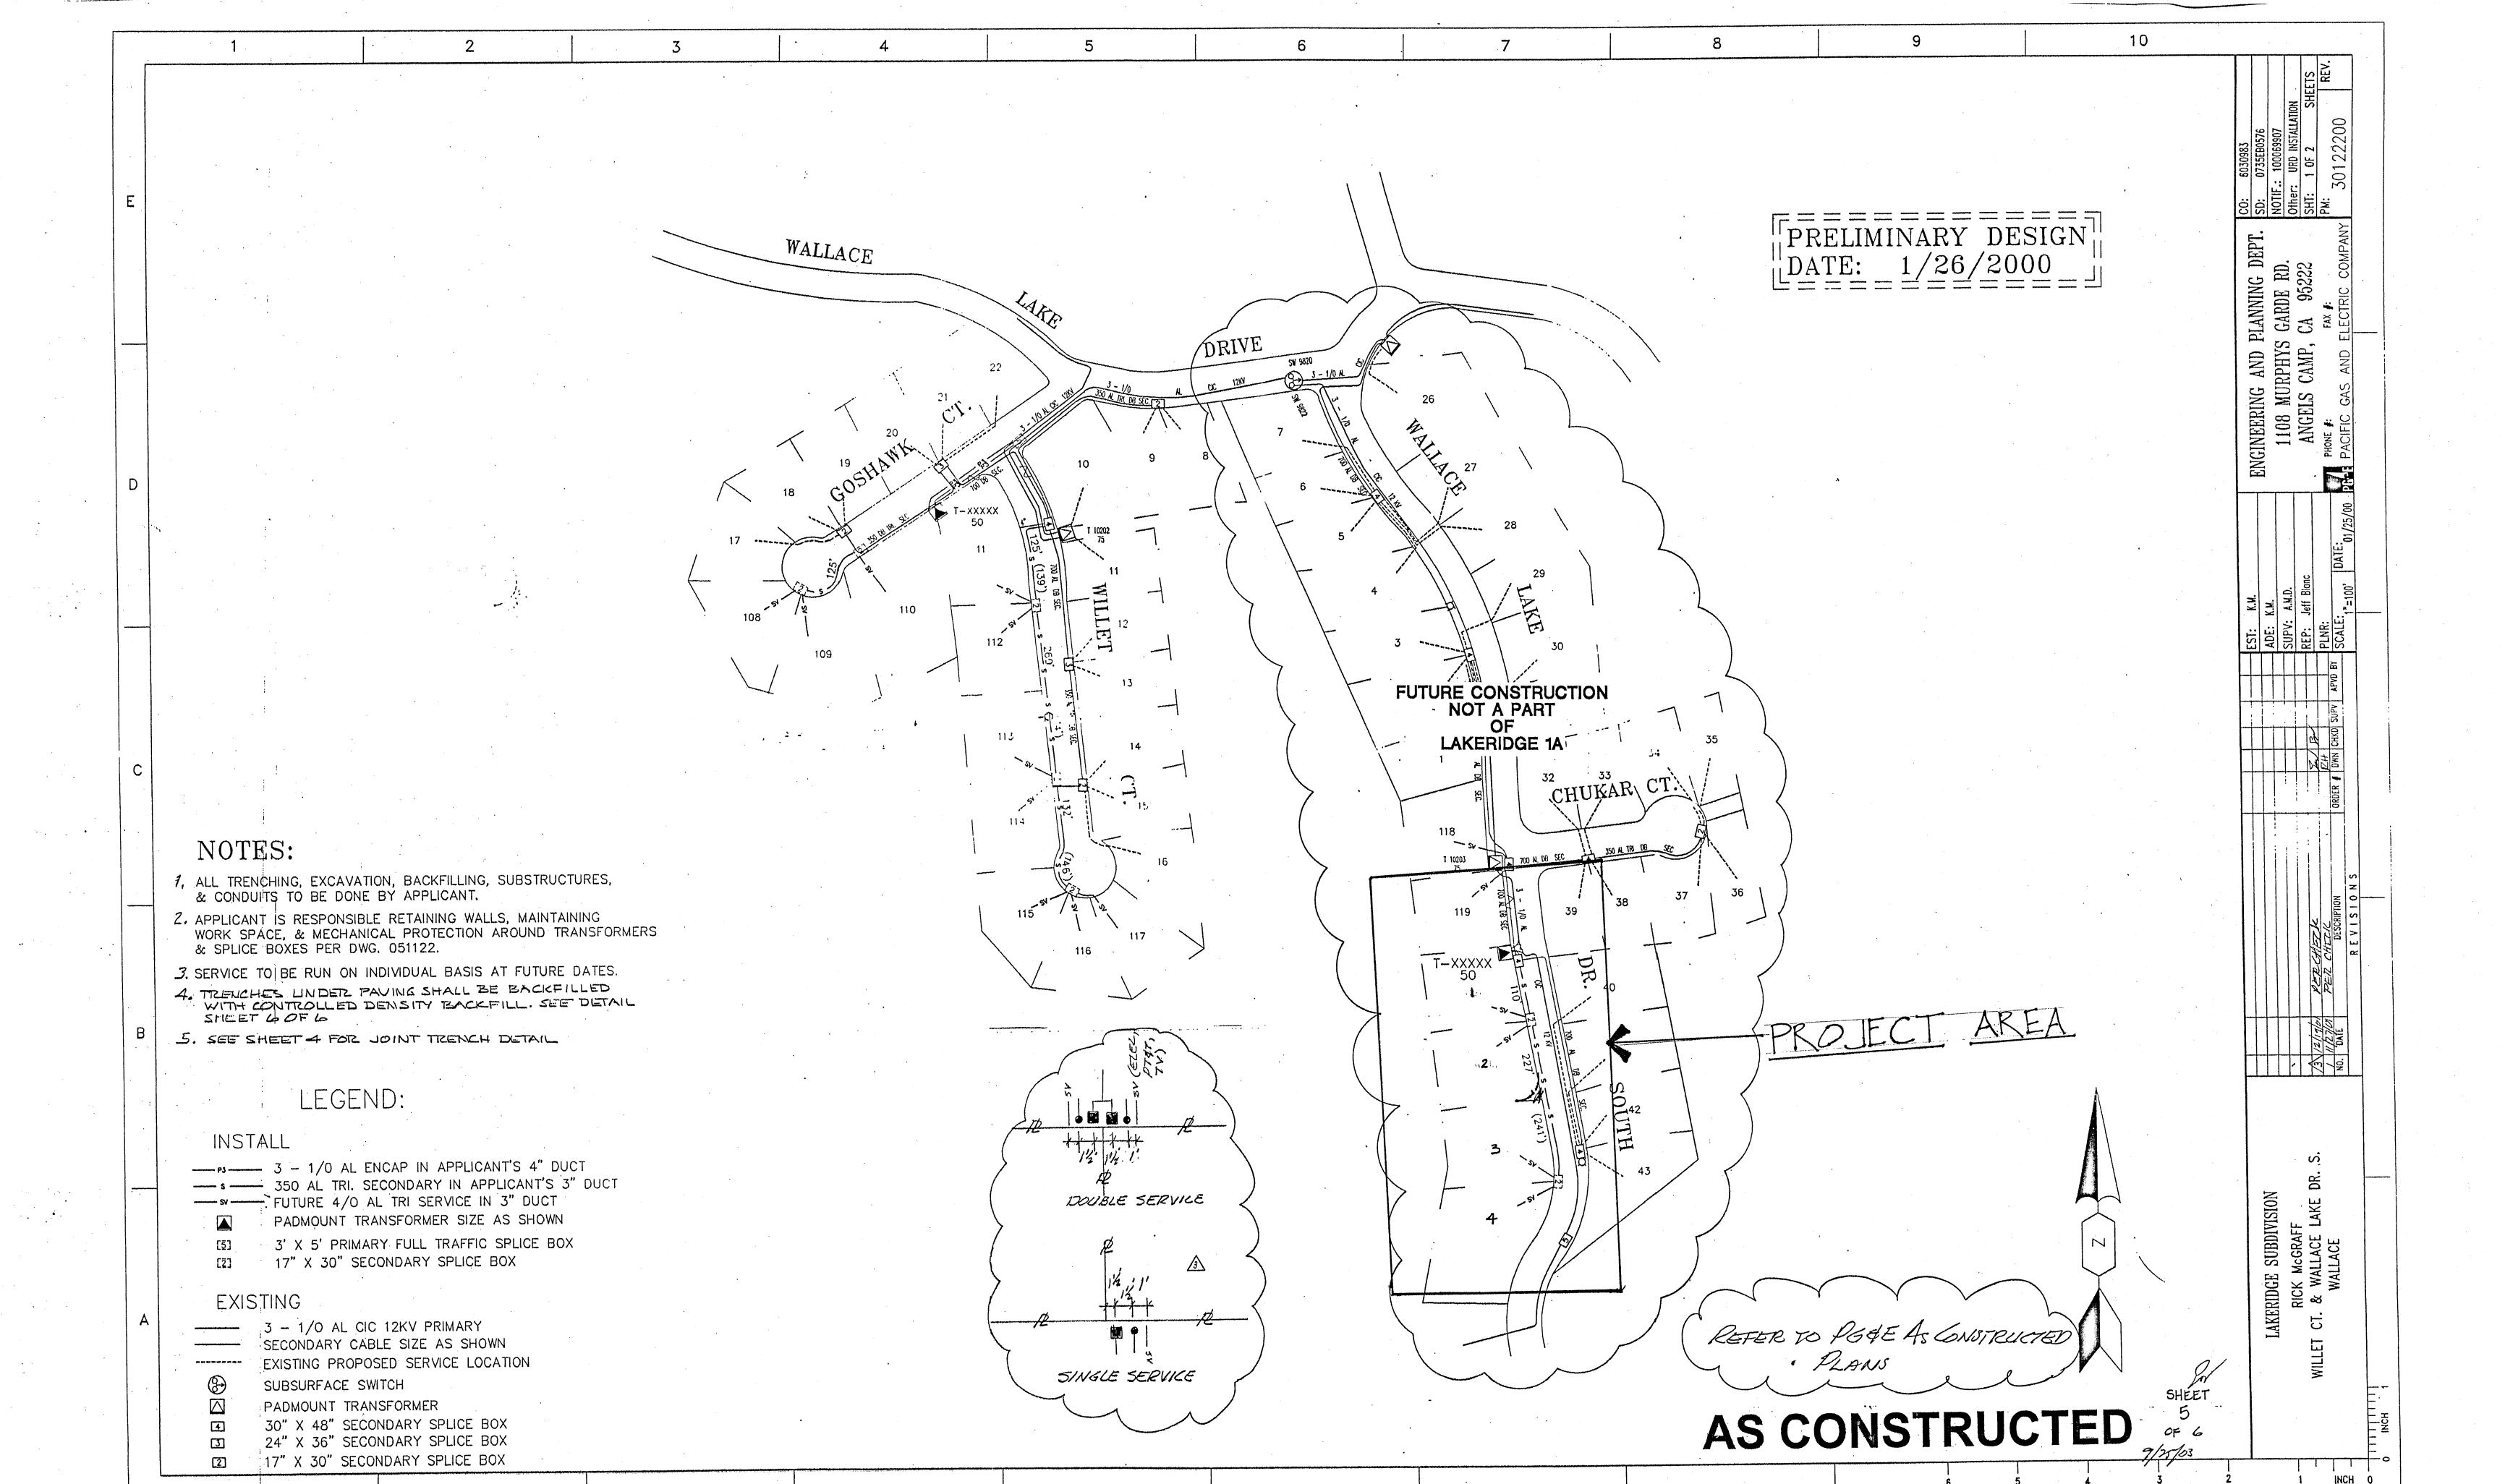

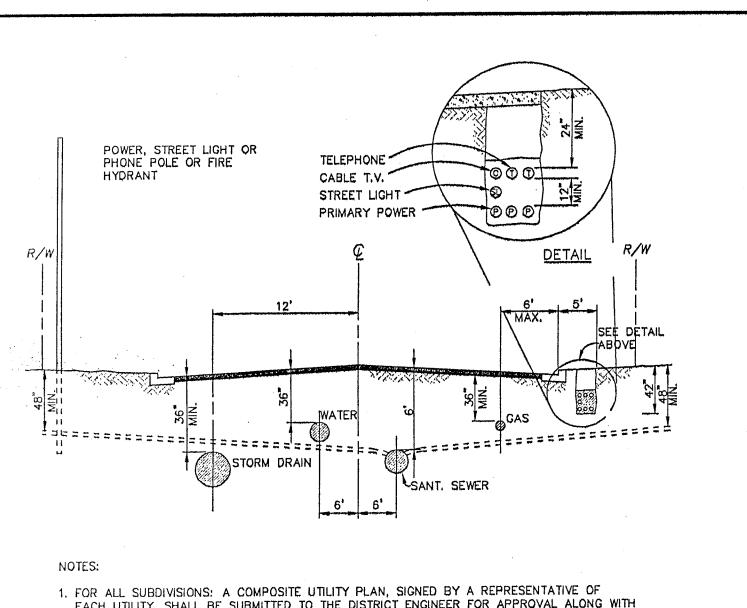

- EACH UTILITY, SHALL BE SUBMITTED TO THE DISTRICT ENGINEER FOR APPROVAL ALONG WITH THE CONSTRUCTION DRAWING PACKAGE.
- 2. JOINT TRENCH (FOR UTILITIES ONLY) MAY BE USED WHERE APPLICABLE PROVIDED STATE AND LOCAL ORDINANCES AND UTILITY COMPANY REQUIREMENTS ARE MET.
- 3. ALL SEWER MAINS AND LATERALS SHALL CROSS UNDER WATER MAINS AND SERVICES WITH A MINIMUM OF ONE FOOT OF CLEARANCE.

REVISIONS				
DATE	NO.		UTILITY LOCATIONS	
	OPUZ. TS	VACATI,	Wallace Community Services District P.O. Box 398	
CH CHECKED		1	Wallace, California 95254 Telephone/Facsimile: (209) 763—2882	
JUL 04	PROJECT	NQ.	STD. W-1	

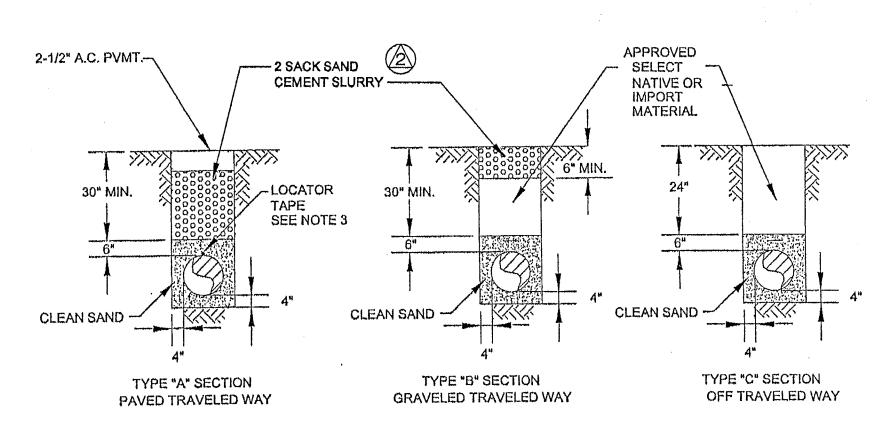



- 1. BEDDING MATERIAL SHALL BE CLEAN IMPORTED SAND AND PROPORTIONED AS SHOWN ABOVE. 3/8" PEA GRAVEL OR 3/4" CRUSHED ROCK SHALL BE USED AT BOTTOM OF PIPE IN WETTED AREAS OR AREAS OF HIGH GROUNDWATER.
- 2. PLACEMENT SHALL PROVIDE A FIRM, SMOOTH, UNIFORM BOTTOM FOR PIPE SUPPORT.
- 3. LOCATOR TAPE SHALL BE TAPED TO THE TOP OF THE PIPE.
- 4, ALL BACKFILL SHALL BE COMPACTED IN 6" LIFTS TO 95% MAXIMUM DENSITY. 5. SELECT NATIVE MATERIAL OR IMPORT SHALL BE FREE FROM ORGANIC OR DELETERIOUS MATERIAL, AND NO ROCKS OVER 3" DIAMETER.
- 6. SLURRY CEMENT BACKFILL MAY BE REQUIRED FOR TYPE A SECTION WHEN DIRECTED BY THE DISTRICT ENGINEER.

REVISIONS			
OYIE	110, 51	TRENCH BACKFILL DETAILS	
IIGREZ, WERT.		Wallace Community Services District P.O. Box 398	
рважн СН	CHECKED RTW	Wallace, California 95254 Telephone/Facsimile: (209) 763—2882	
APR 04	PROJECT HO.	STD. 55-2	

10' MIN. SEPARATION

WATER TO SEWER

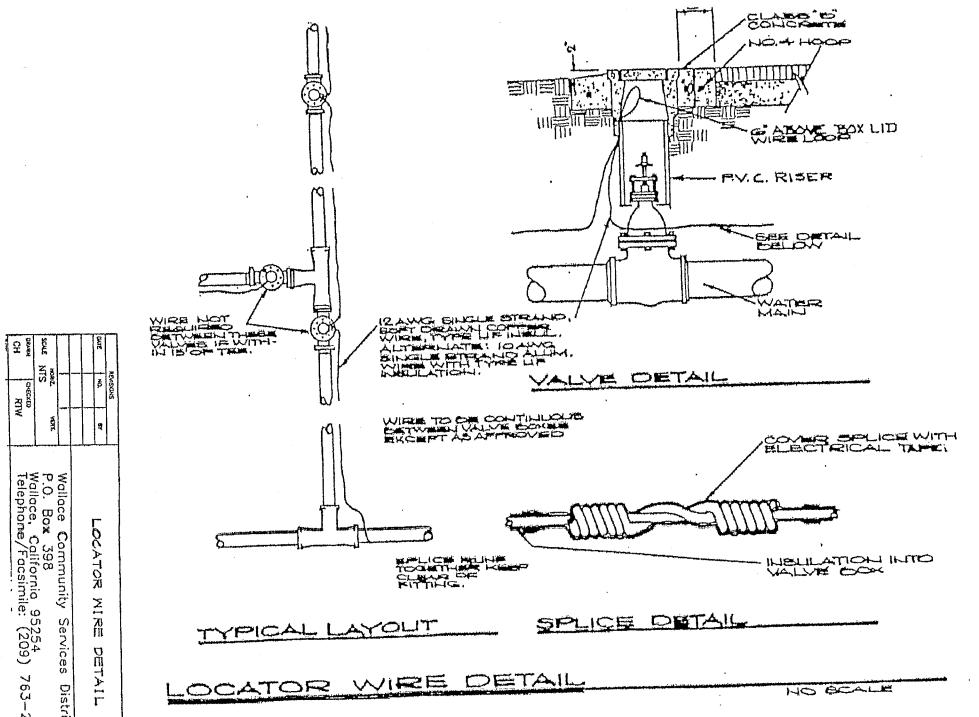

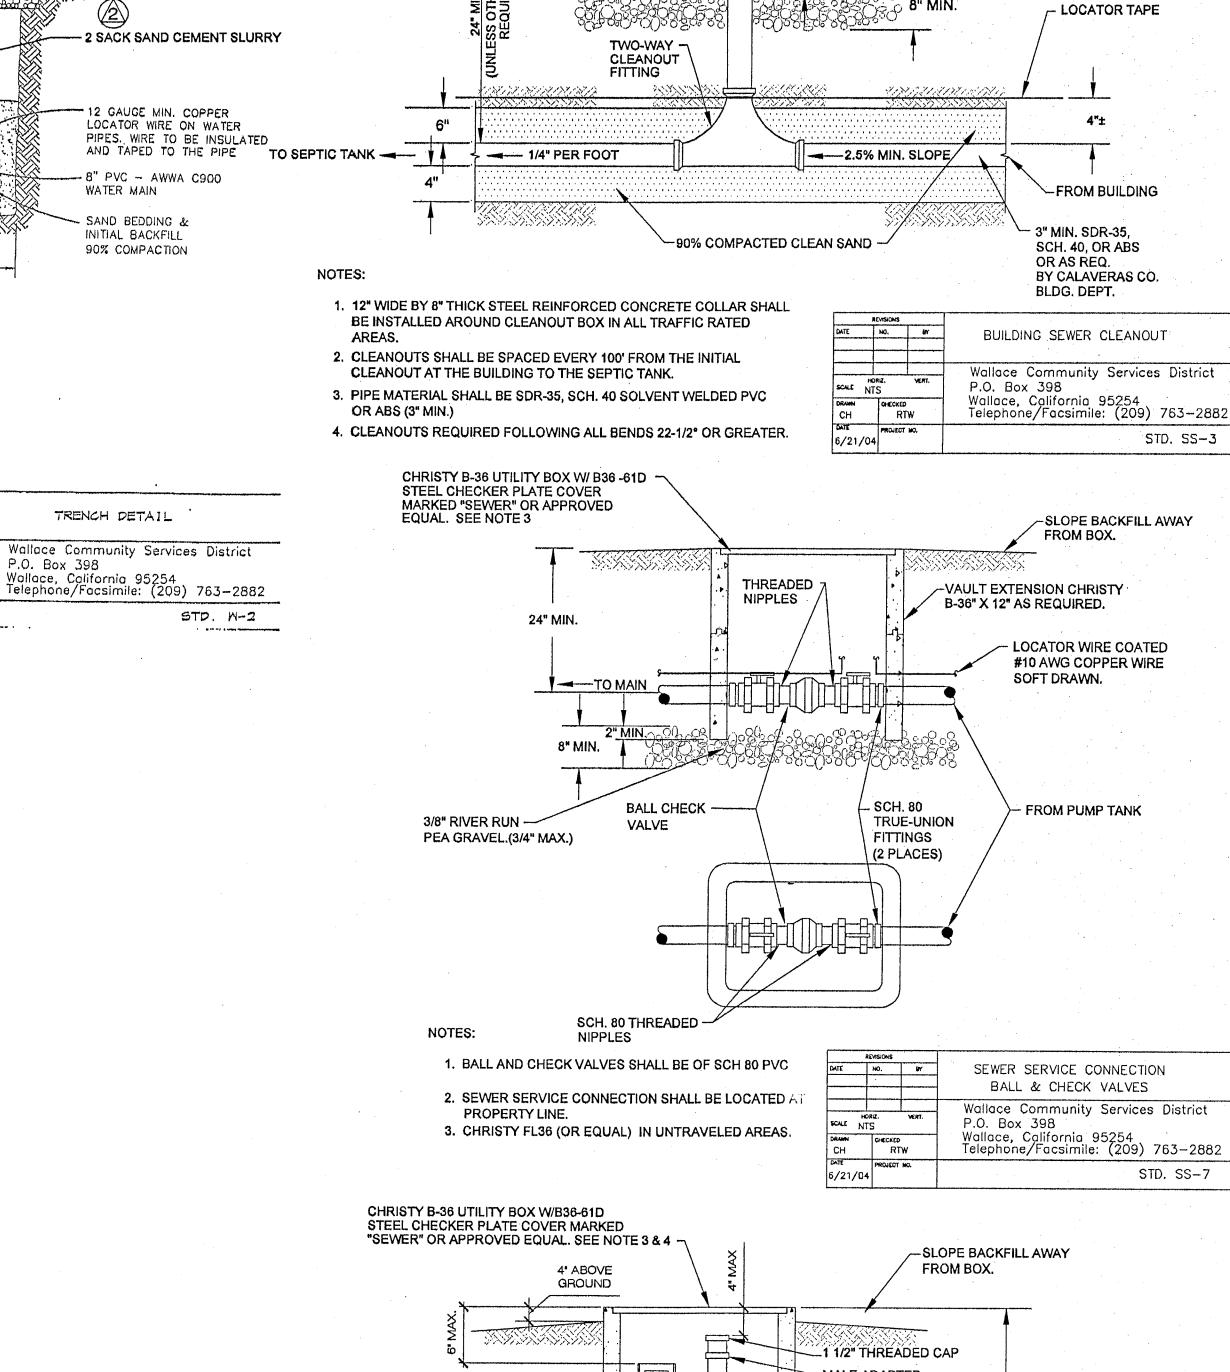

SCREW CAP TYPE

(NO PLUG TYPES)

#4 REBAR LOOP

CONC. COLLAR

IN TRAFFIC AREA ONLY.

2" AC OVER 6" AB

SAND BEDDING &

INITIAL BACKFILL

90% COMPACTION

TRENCH DETAIL

P.O. Box 398


24" MIN.

MAXIMUM

JUL 04

TRENCH WIDTH

· SAWCUT A.C. AND CONCRETE

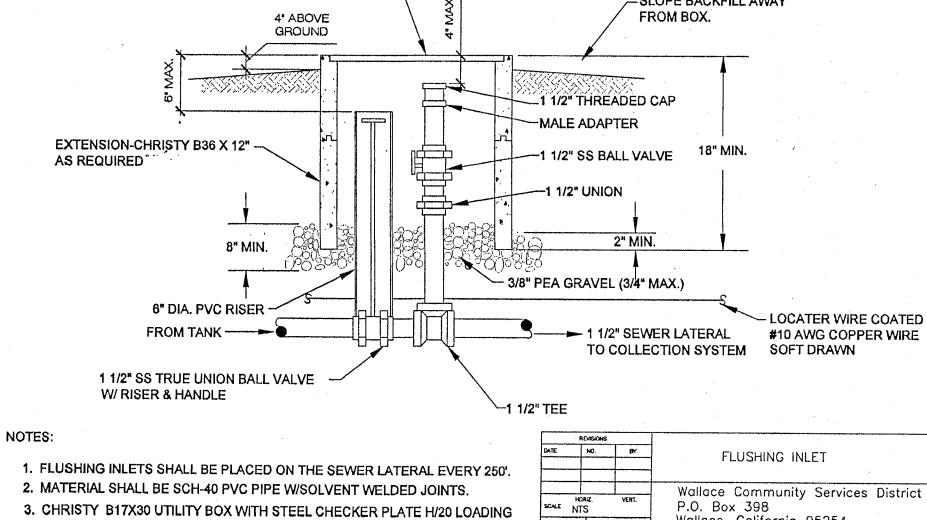

4. CHRISTY FL36 (OR EQUAL) IS ACCEPTABLE IN UNTRAVELED AREAS.

### Wollace, California 95254 Telephone/Facsimile: (209) 763-2882 CHECKED RTW MARKED "SEWER," OR APPROVED EQUAL, FOR ALL TRAFFIC RATED AREAS. 6/21/04 PROJECT NO. STD. SS-8

-CHRISTY G-5 CONCRETE BOX WIMETAL LID MARKED "SEWER".

(IN TRAFFIC AREA)

"SEWER".

-CHRISTY FL8 IN UNTRAVELED

AREA (OR EQUAL). LID MARKED

6" MIN. CLASS B

4"±

STD. SS-3

STD. SS-7

- LOCATER WIRE COATED

REVISIONS =

WEATHERBY-REYNOLDS-FRITSON

ENGINEERING AND DESIGN

LIC. EXP. 03/31/07

(209)-223-0381 [Voice] (209)-223-0716 [Fax]

206 Peek Street
Jackson, CA. 95642
http://www.wrfed.com

THESE DRAWINGS AND THE CONCEPT

EMBODIED THEREIN ARE THE ORIGINAL UNPUBLISHED WORK OF WRF ENGINEERING AND DESIGN AND SHA

NOT BE USED OR DUPLICATED WITHOU

DRAWINGS **2** 

WATER AND

SEWER

FILE NO.

SCALE

SHEET

DRAWN BY

DETAILS

THE WRITTEN AGREEMENT OF TERR WEATHERBY, GRANT REYNOLDS, OR

KEVIN FRITSON

D-5598

05-2006

AS NOTED


6 OF 6 SHEETS

206 Peek Street

CONCRETE

# **APPROVALS**

- THIS DRAWING IS NOT FINAL AND IS NOT TO BE USED FOR CONSTRUCTION UNTIL STAMPED AND WET-SIGNED BY THE PROJECT ENGINEER. Construction contractor agrees that in accordance with generally accepted construction practices, construction
- contractor will be required to assume sole and complete responsibility for job site conditions during the course of construction of the project, including safety of all persons and property; that this requirement shall be made to apply ontinuously and not be limited to normal working hours, and construction contractor further agrees to defend, indemnify and hold design professional harmless from any and all liability, real or alleged, in connection with the performance of work on this project, excepting liability arising from the sole negligence of design professional.

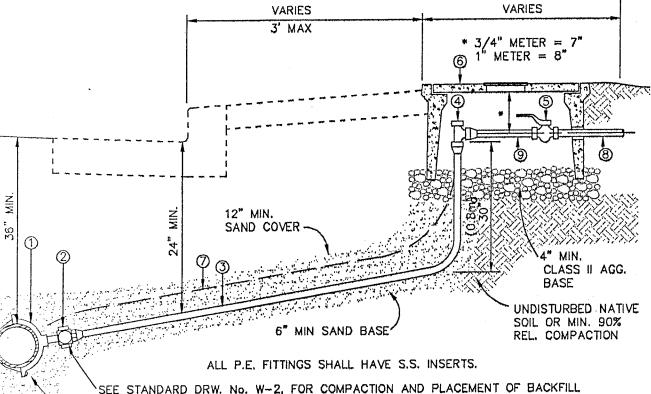

SEE STANDARD DRW. No. W-2, FOR COMPACTION AND PLACEMENT OF BACKFILL SEE STANDARD DRW. No. W-1, FOR LOCATION OF WATER MAIN AND DEPTH.

- (1) SERVICE CLAMP: STAINLESS STEEL DOUBLE-STRAP (4 BOLTS) BRONZE SADDLE, FOR 1" TAP, AS LISTED OR EQUAL APPROVED BY THE DISTRICT ENGINEER. MUELLER H-16100 SERIES OR JONES J-979 OR ROMAC 202 B5 FOR C-900 PVC
- ② CORPORATION STOP: 1" CORPORATION STOP, STRAIGHT COUPLING, MUELLER H-15050 OR FORD F-1000 OR JONES J-3401
- 3 SERVICE RISER: MIN. SERVICE TO METER IS 1" POLYETHYLENE (P.E.) COPPER TUBING SIZE.
- 4 METER VALVE: SHALL BE LOCKABLE IN OFF POSITION. 3/4" METER - 1"x3/4" FORD No. KV43-342W OR JONES J4201 OR EQUAL 1" METER - 1" FORD No. KV43-444W OR JONES 1963W OR APPROVED EQUAL
- (5) CUSTOMER SERVICE BALL VALVE: INSTALL ON CUSTOMER SIDE. 3/4" - FORD B-13-332 W " - FORD B - 13-444
- 6 METER BOX: CHRISTY R136 INSTALL 1/4" RODENT SCREEN BOTTOM OF METER BOX TYPICAL.
- DI LOCATOR WIRE: USE 12 GAUGE COPPER WIRE INSULATED FOR ALL SERVICE ASSEMBLIES. TIE TO LOCATER WIRE ON MAIN LINE FROM ANGLE STOP VALVE.
- 9 BLANKED METER IDLER FORD MO. 2, 7-1/2" LENGTH TYPICAL.

REVISIONS			
DATE	NG.	1" WATER SERVICE	
HORZ, VERT, SCALE NTS		Wallace Community Services District P.O. Box 398	
DRAMM CH	CHECKED RTW	Wallace, California 95254 Telephone/Facsimile: (209) 763—288	
JUL O	PROJECT NO.	STD. W-4	

