

Improvement Plan for Mokelumne Oaks Subdivision

Being a subdivision lying in the portion of the N.E. 1/4 of sec. 22, and
sec. 23, T.4.N., R. 9.E., M.D.M., CALAVERAS COUNTY, CALIFORNIA

GENERAL NOTES:

- It is intended that these plans and specifications require all labor and materials necessary and proper for the work contemplated and that the work be completed in accordance with their true intent and purpose.
- All improvements shall be constructed in conformance with the requirements of the entity having jurisdiction over the work as follows:
COUNTRY OF CALAVERAS - Street Improvements & drainage facilities.
WALLACE LAKE COMMUNITY SERVICE DISTRICT - Water & Sewer Facilities.
PG&E - Electric
SAC - Telephone
- All road construction shall be in conformance with Calaveras County Standards and Caltrans Standard Specifications (Latest Edition). All grading shall comply with Appendix Chapter 33 of the California Building Code and, as applicable, with recommendations made by the soils engineer.
- The contractor is responsible for arranging a pre-construction meeting prior to the anticipated start of construction.
- A copy of an approved set of these plans must be on site during construction.
- The contractor shall be responsible for all permits and licenses required for the construction and completion of this project.
- The contractor agrees to assume sole and complete responsibility for job site conditions during the course of construction, including safety of all persons and property, that this requirement shall apply continuously and not be limited to normal working hours; and that the contractor shall defend, indemnify and hold the owner and the engineer harmless from any and all liability, real or alleged, in connection with performance of work on this project, excepting for liability arising from the sole negligence of the owner or the engineer.
- The contractor shall exercise caution in the protection of existing facilities. The contractor shall carefully preserve benchmarks, reference points and stakes, and shall bear all expenses for replacement and/or errors caused by their unnecessary loss or disturbance.
- The contractor shall become familiar and comply with the standards and specifications of agencies having jurisdiction over the work. Agency standards shall govern when in conflict with the plans. Specifications, specific notes and detail drawings herein and in the geotechnical report take precedence over general drawings and plans unless otherwise directed by the engineer, an deviation from approved plans during construction will require 48 hours prior written notice to the engineer, county and other appropriate public agencies and approval by same.
- The contractor shall verify location of all existing underground utilities and shall contact via respective utility companies prior to commencement of work. The contractor shall be responsible for the location and preservation of all such facilities in the area of construction, and shall notify utility companies 48 hours prior to excavation. Engineer shall be notified of any location or depth discrepancies. Responsibility of the contractor to comply with California Government Code 4216 as applicable. To obtain a dig alert identification number, call 800-227-2600 at least two working days before digging underground.
- (Underground Service Alert 1-800-227-2600)
- A reasonable effort has been made to locate and delineate all underground utilities and obstructions through topographic information. Pedersen Engineering Incorporated assumes no responsibility for the completeness of this effort or for the existence of other buried objects or utilities which may be encountered but which are not shown on these drawings. It is the contractor's responsibility to verify the location of utilities.
- The contractor shall become familiar and comply with plans, notes, details and specifications prior to the start of construction.
- Construction hours shall be limited to the daytime hours between 7:00 am and 6:00 pm, and all construction equipment shall be properly muffled and maintained.
- Contractor shall give the agency (inspector) having jurisdiction over a particular work forty-eight (48) hours notice before commencing such work.
- Contractor is responsible for coordination of the removal or re-location of all existing utilities with the respective utility company. Cost of this coordination is to be included in the prices bid for the various improvements to complete the project.
- All trench excavation five feet or more in depth shall be done in conformance with appropriate standard shoring system. CAL-OSHA safety requirements shall be in effect during all construction. Special safety precautions shall be taken when working in the vicinity of gas, oil or electrical lines.
- The disposition of all fences, brush, culverts and any other material unusual for grading and underground obstacles such as wells, tanks, irrigation lines shall be the responsibility of the contractor as directed by the engineer in accordance with local agency requirements.
- Grades shown on the plan are finished grades unless otherwise specifically noted. It will be the contractor's responsibility to determine finished surfaced elevations of base courses, sub-grades, etc.
- Construction staking shall be in place prior to starting excavation and embankment. The contractor shall be responsible for 48-hour prior notification to the engineer for all staking requests. The contractor shall be responsible for maintaining construction survey stakes and will be charged for all re-staking.
- The report entitled "Geotechnical Services Report proposed Mokelumne Oaks, Wallace California" by Kleinfelder, Inc., dated April 18, 2002 is made a part of these plans.
- The contractor shall be responsible for the workmanship, actions and safety of contractor's employees during the construction operation and shall maintain workers' compensation insurance on all employees and employees of subcontractors.
- Any contractor employee that becomes abusive or threatening to the owner, engineer, their authorized agents, agency inspectors or any member of the general public shall be restricted from any further work or access to the site, by the contractor upon notification by the owner.
- The contractor shall be responsible for maintaining sanitary facilities onsite during the construction operation.


PEDERSEN ENGINEERING INC. Projects Worldwide - Mokelumne Oaks Improvement Plan - Sheet 1 of 12

CALAVERAS COUNTY, CALIFORNIA


OWNER/DEVELOPER: MR. JOHN D. REYNAN
9848 BUSINESS PARK DR., SUITE H
SACRAMENTO, CA 95827

EROSION CONTROL NOTES

- Refer to general and grading notes shown on this sheet.
 - Temporary erosion control devices shown on the grading plan, which interferes with the work, shall be relocated or modified when the engineer of work so directs as the work progresses.
 - All loose soil and debris shall be removed from the street areas upon starting operations and periodically thereafter as directed by the engineer of work. Adjacent properties shall be protected from storm water, mud, silt, etc. Contractor must have tools and equipment to provide erosion control measures made necessary by a construction operation on the job site before beginning work.
 - Min. 12" earth berms shall be constructed and maintained along the top of the slope of those fills on which grading is not in progress. Hydroseeded all fill and cut slopes including approved borrow site and haul roads as soon after grading is practical. Hydroseeding shall be completed by October 15, otherwise supplemental seeding measures as specified under special winterization requirements must be applied.
 - Provide velocity check dams in all unpaved street areas at the intervals indicated below. Velocity check dams shall be constructed of sandbags, straw bales or mountable berms as approved by the inspector, and shall conform to the erosion control plan. Roadway check dams shall be completed by October 15.
- | | |
|---------------------------|----------|
| Grade of ground or street | Interval |
| Less than 2% | 300 feet |
| 2% to 4% | 100 feet |
| 4% to 10% | 60 feet |
| Over 10% | 30 feet |
- All erosion control measures shall be in place at the end of each working day when the forecast of rain probability exceeds 40% and will be operable and maintained during the rainy season (October 15 to April 15).
 - Straw bales or sandbags must be full and shall be stockpiled adjacent to each point of use as shown on the plans, and ready to be placed in position when the rain forecast is 40% or greater, or when directed by the inspector. Approved sandbag material sand, decomposed granite, and/or gravel or other materials approved by the engineer of work.
 - Changes to the approved erosion control plans to meet field conditions will be made only with approval of the engineer of work and the Calaveras County Department of Public Works.
 - All paved areas will be kept clear of earth material and debris. The site will be maintained so that a minimum of sediment laden runoff enters the storm drainage system.
 - As storm drain improvements are constructed, all structures and inlet pipes shall be protected from flow of sediment by straw bales, silt fence, or gravel per details, and no sediment shall leave the project site.
 - Any lined ditches and any rock slope and outlet protection shall be installed prior to October 15th of each year.
 - All slopes and graded areas will be hydroseeded per the erosion control seeding specifications shown on Sheet 4. Affected areas inaccessible to hydroseeding may be hand seeded and covered with punched straw mulch per Caltrans Standard Specifications or approved erosion control fabric. Fabric shall be used on all slopes.
 - Storm water controls shall conform with SWPPP and CALTRANS Storm Water Quality Handbook "Construction Site Best Management Practices (BMPs) Manual," March 2003.

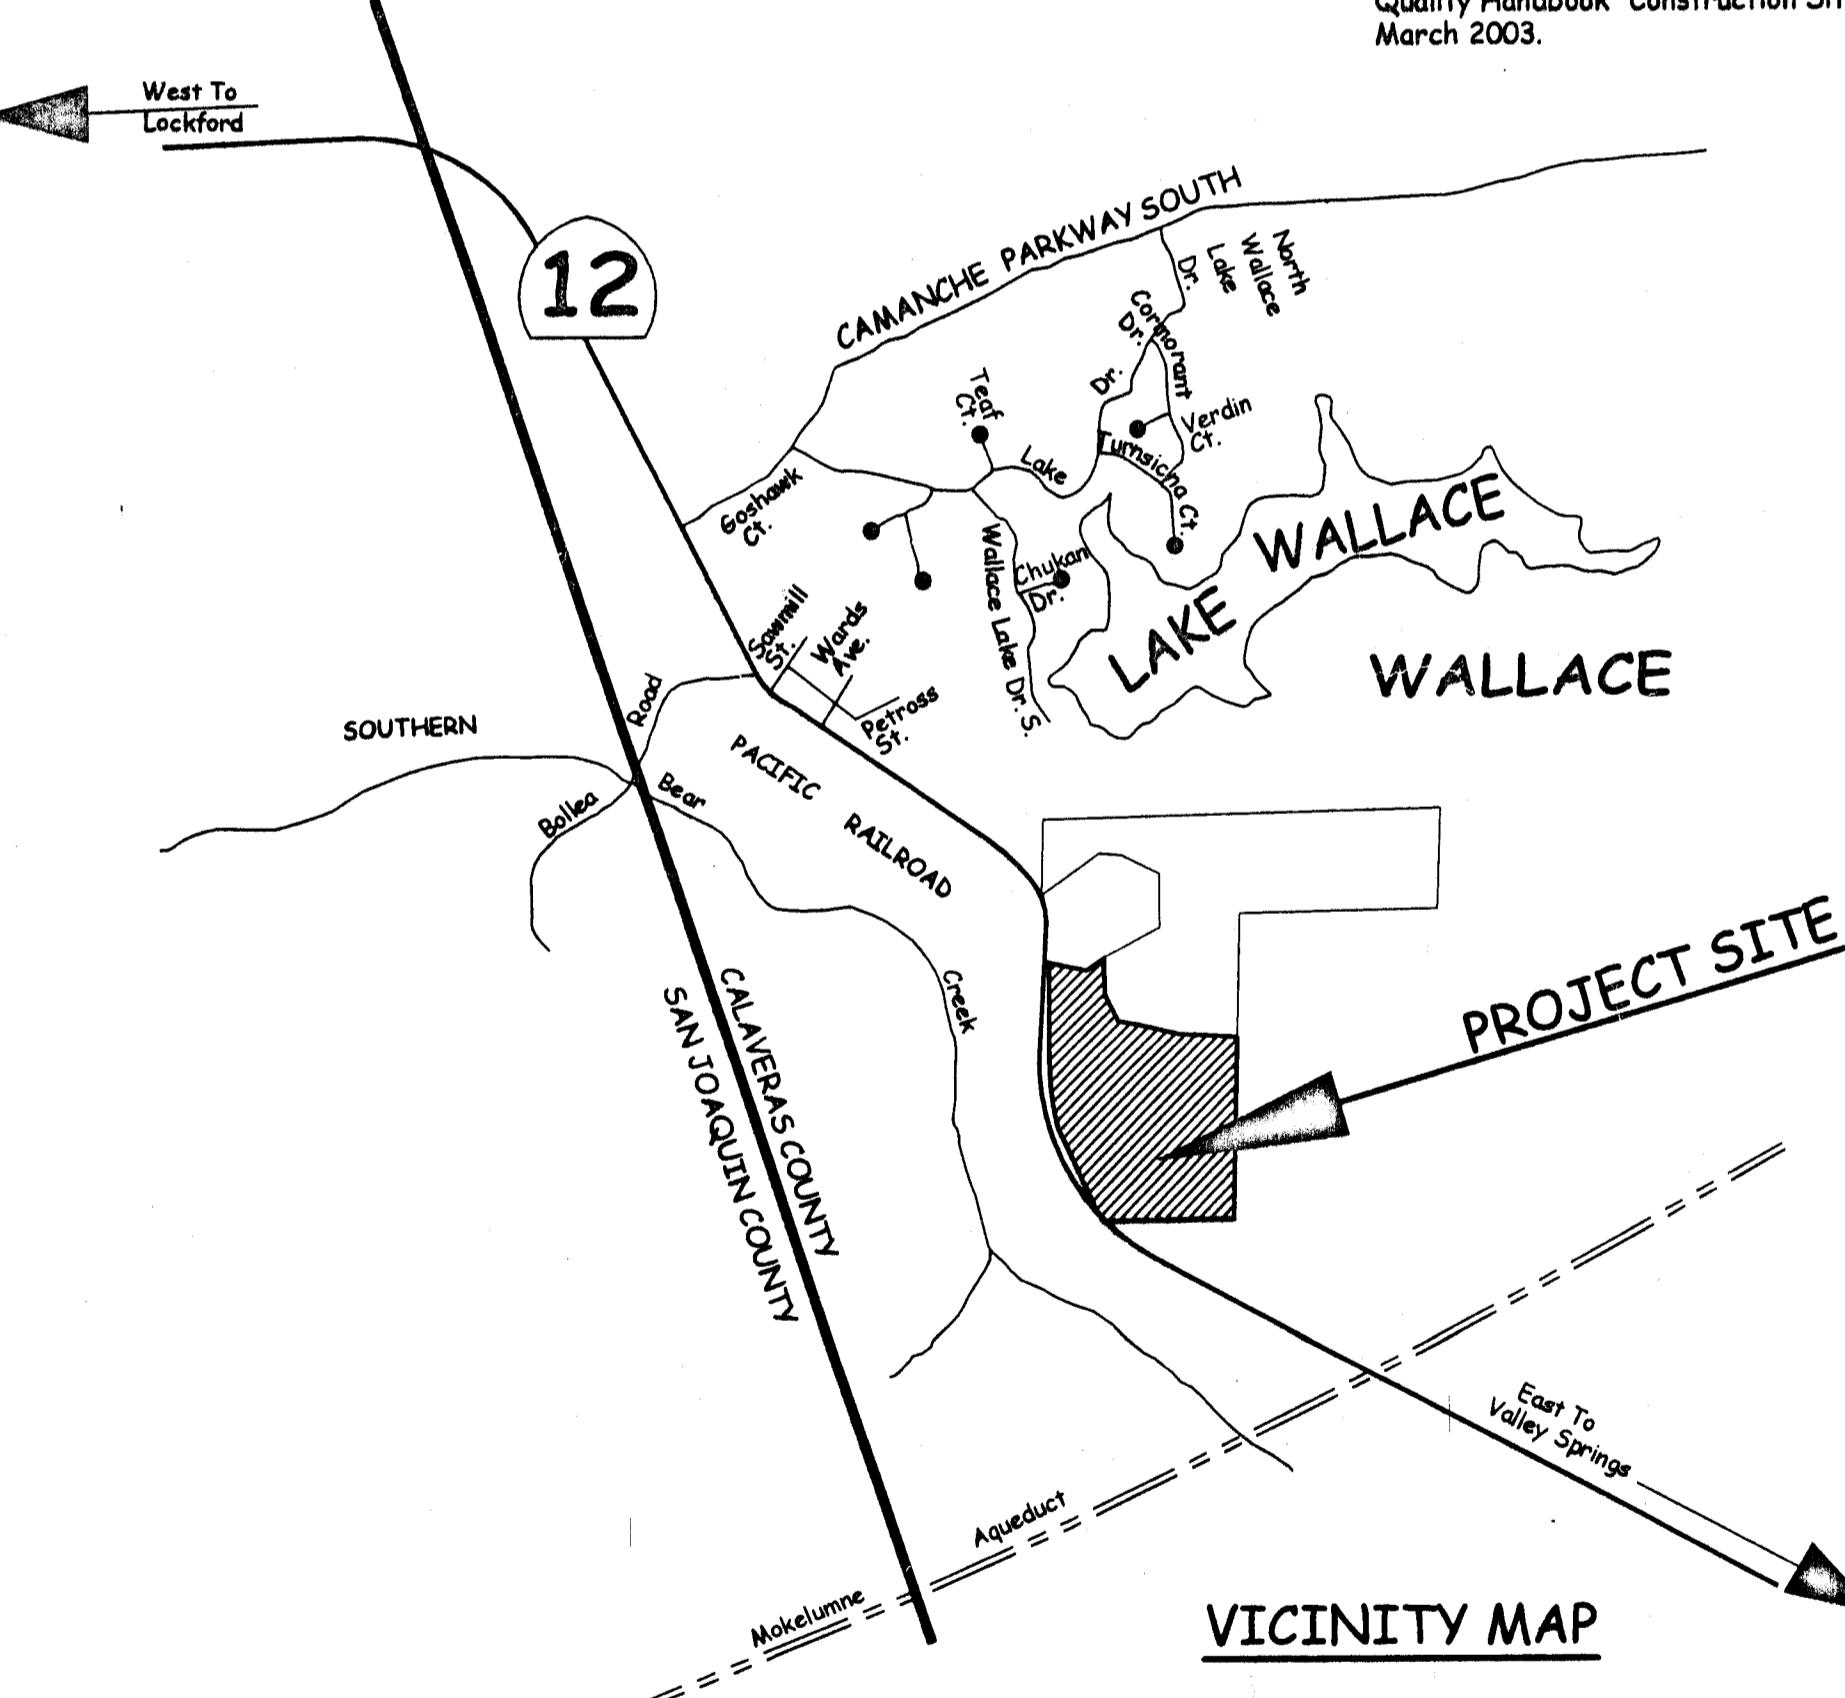

VICINITY MAP

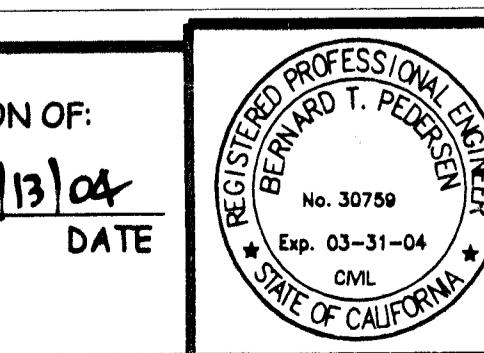

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TITLE SHEET

MOKELUMNE OAKS SUBDIVISION

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- TITLE SHEET
- TYPICAL ROAD SECTIONS
- GRADING PLAN
- EROSION & SEDIMENT CONTROL PLAN
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- PLAN AND PROFILE: Mokelumne Oaks Drive
- PLAN AND PROFILE: Albion Court
- PLAN AND PROFILE: Wallace Parkway
- PLAN AND PROFILE: Wallace Parkway
- DRAINAGE PROFILES
- DETAILS & DRIVEWAY CULVERTS
- SIGNING AND STRIPING

LEGEND

EXISTING	PROPOSED
---230---	210
CONTOUR LINE	STORM DRAIN PIPE
STORM DRAIN PIPE	CMP DOWN DRAIN
CMP DOWN DRAIN	LOT NUMBER
LOT NUMBER	AC DIKE
AC DIKE	WATER WELL
WATER WELL	DRAINAGE DITCH
DRAINAGE DITCH	BVCS
BEGIN VERTICAL CURVE STATION	EVCS
END VERTICAL CURVE STATION	DRIVEWAY LOCATION
DRIVEWAY LOCATION	GMP PIPE INLET
GMP PIPE INLET	FENCE LINE
FENCE LINE	UTILITY POLE
UTILITY POLE	6

CALAVERAS COUNTY PUBLIC WORKS DEPARTMENT
891 Mountain Ranch Road, San Andreas, CA 95249-9709

APPROVED BY: *Robert U. Kawasaki* DATE: 2/16/04
ROBERT U. KAWASAKI, R.C.E. 25622, DIRECTOR OF PUBLIC WORKS










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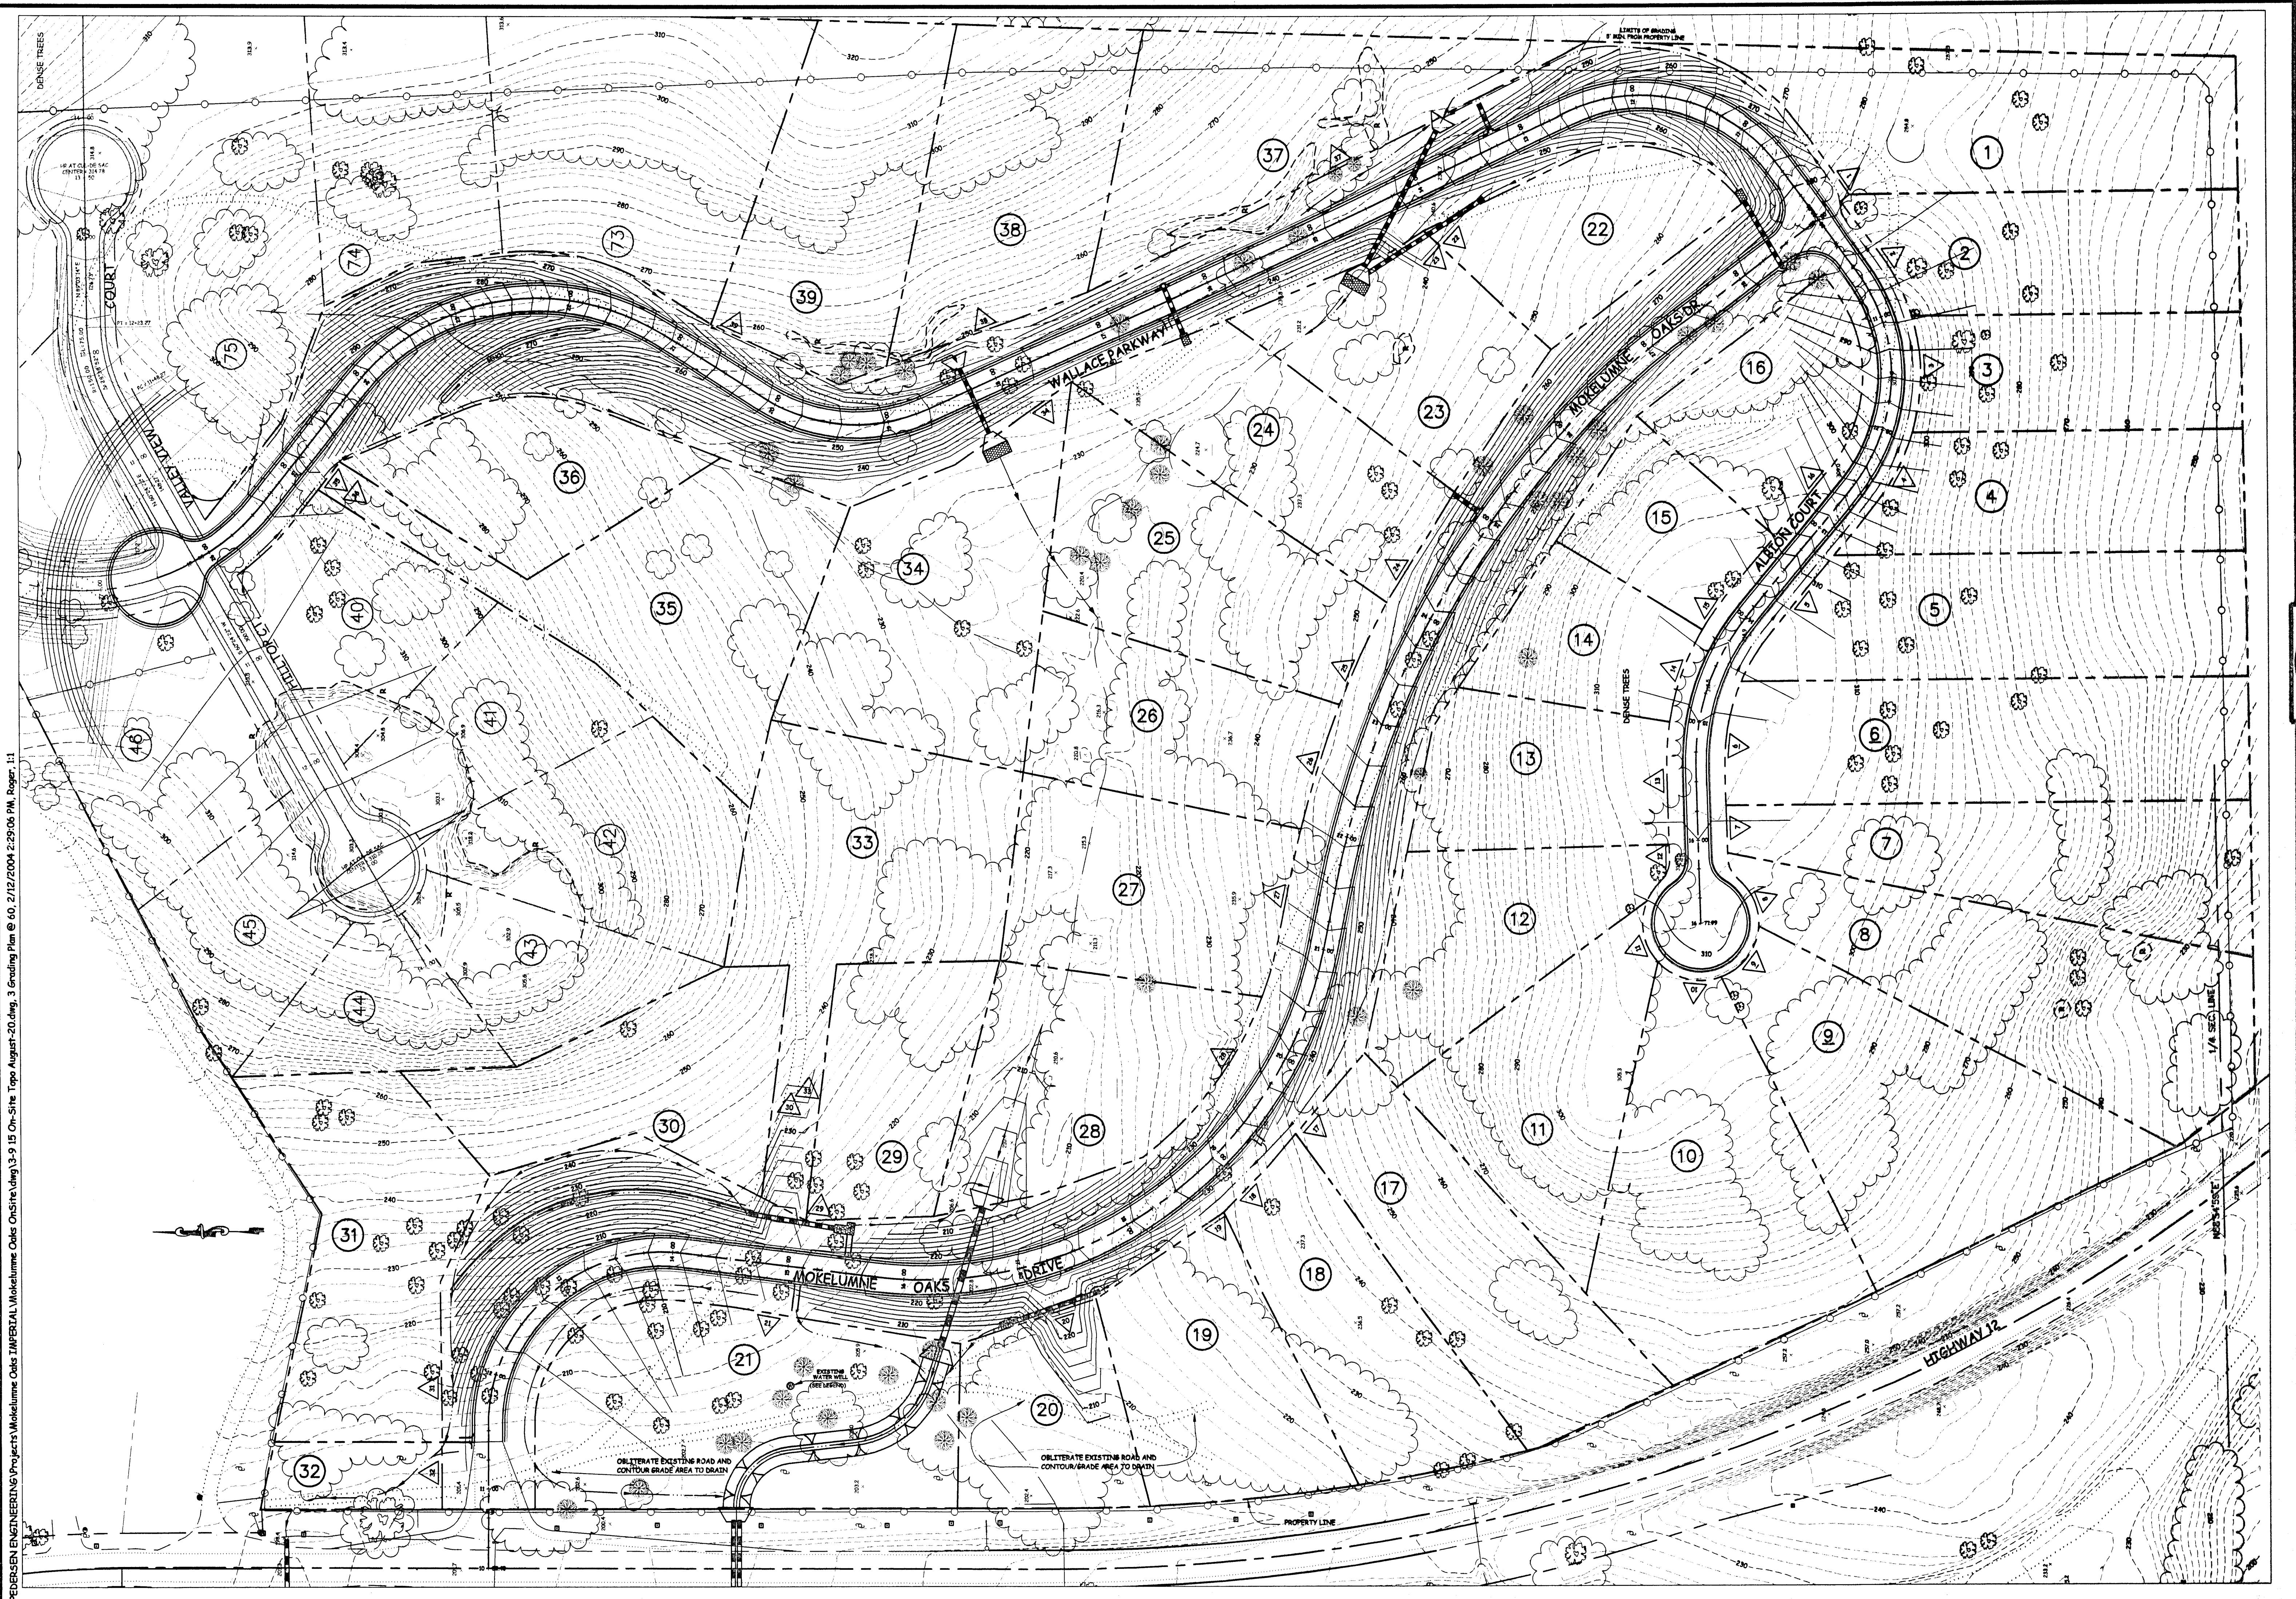
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Bernard T. Pedersen 2/13/04
BERNARD T. PEDERSEN

PROJECT #0206-22	SHEET	1 OF 12



* FINAL PAVEMENT STRUCTURAL SECTION SHALL
BE BASED ON R-VALUE TESTS TAKEN NEAR THE
COMPLETION OF FINISH SUBGRADE.

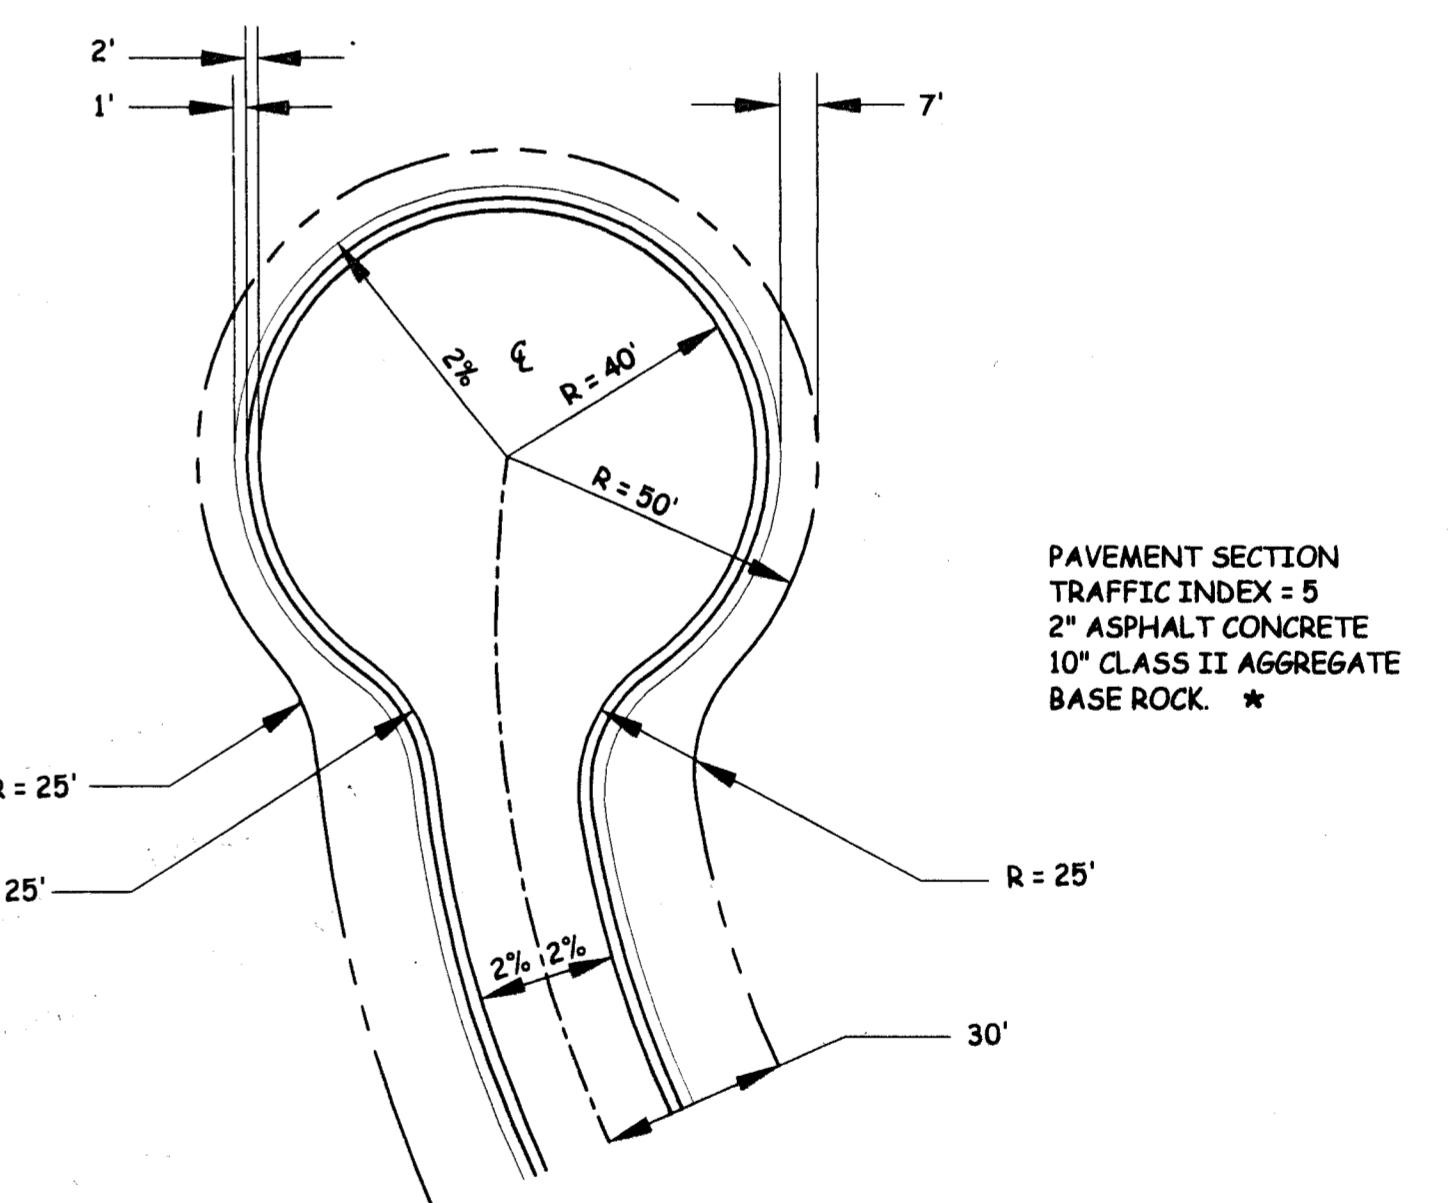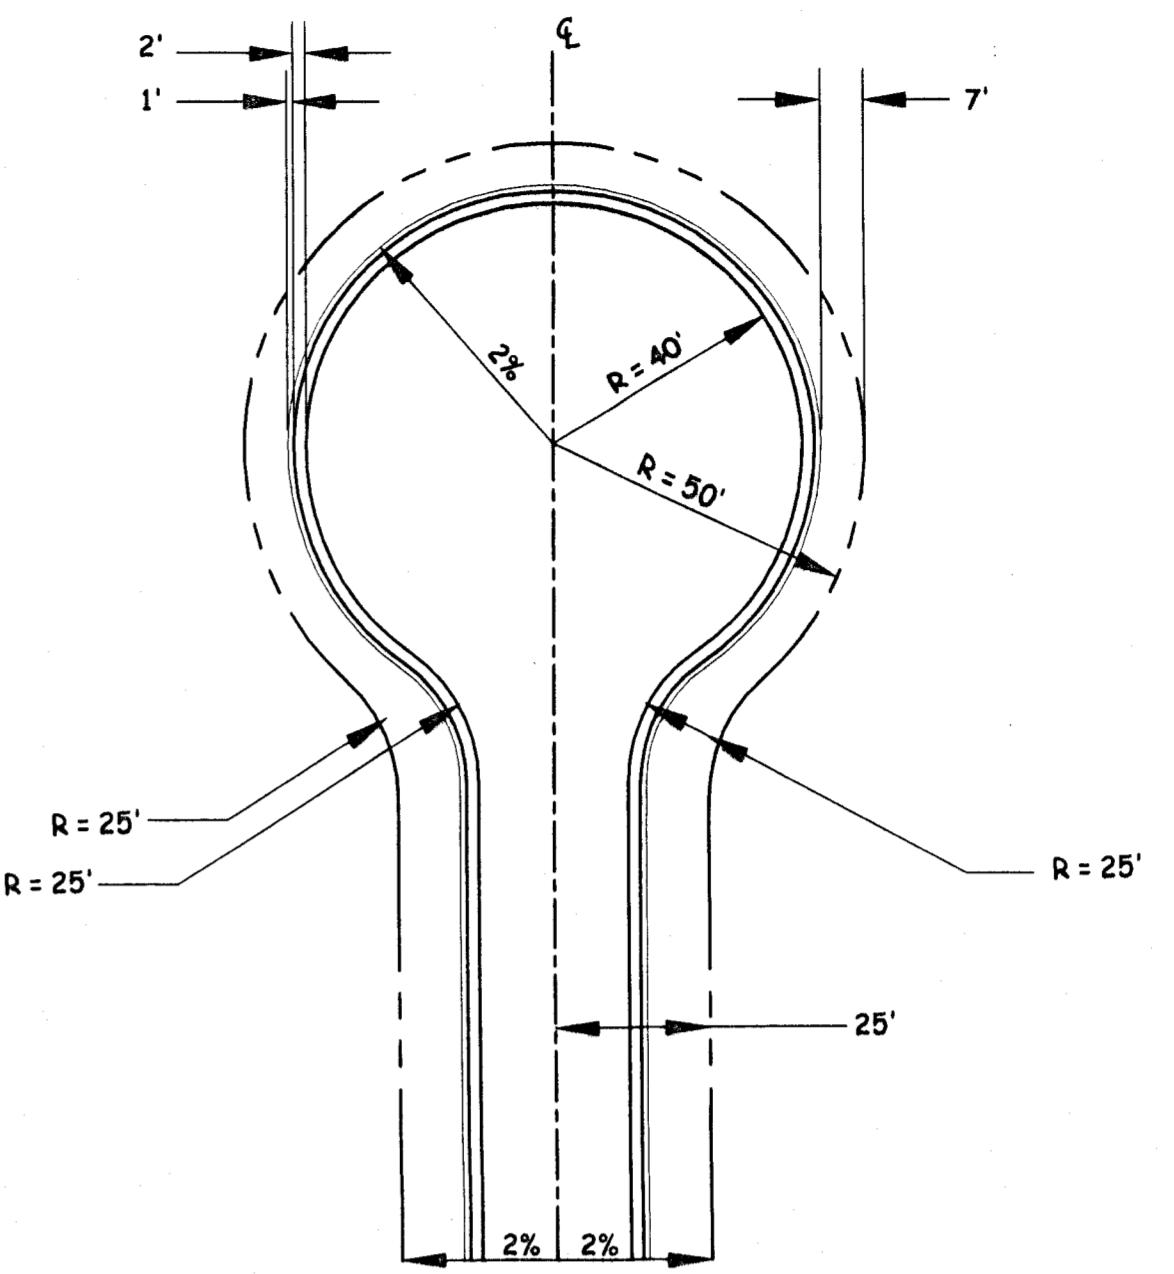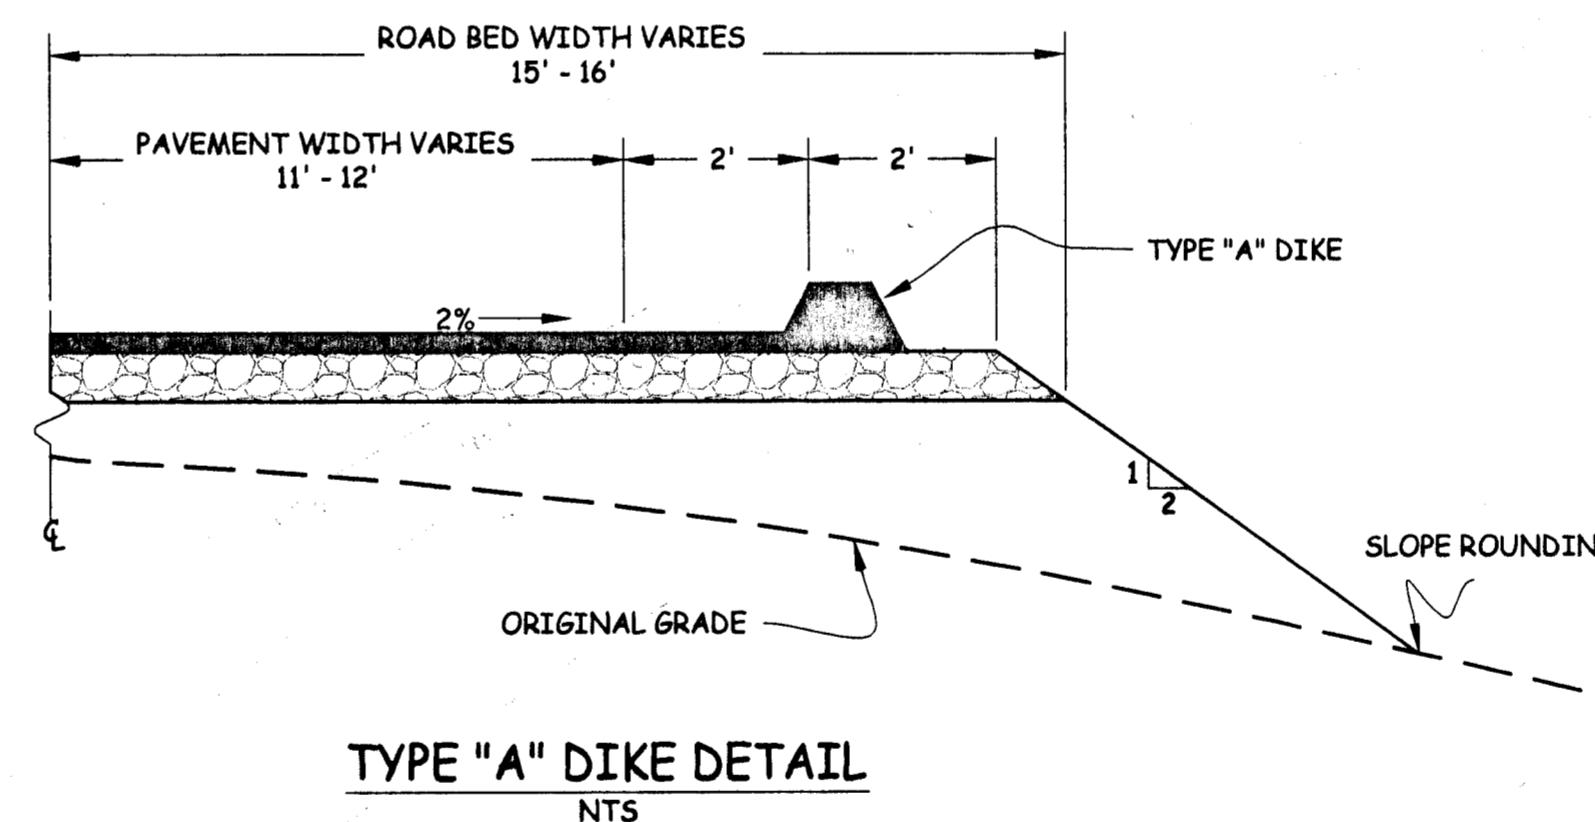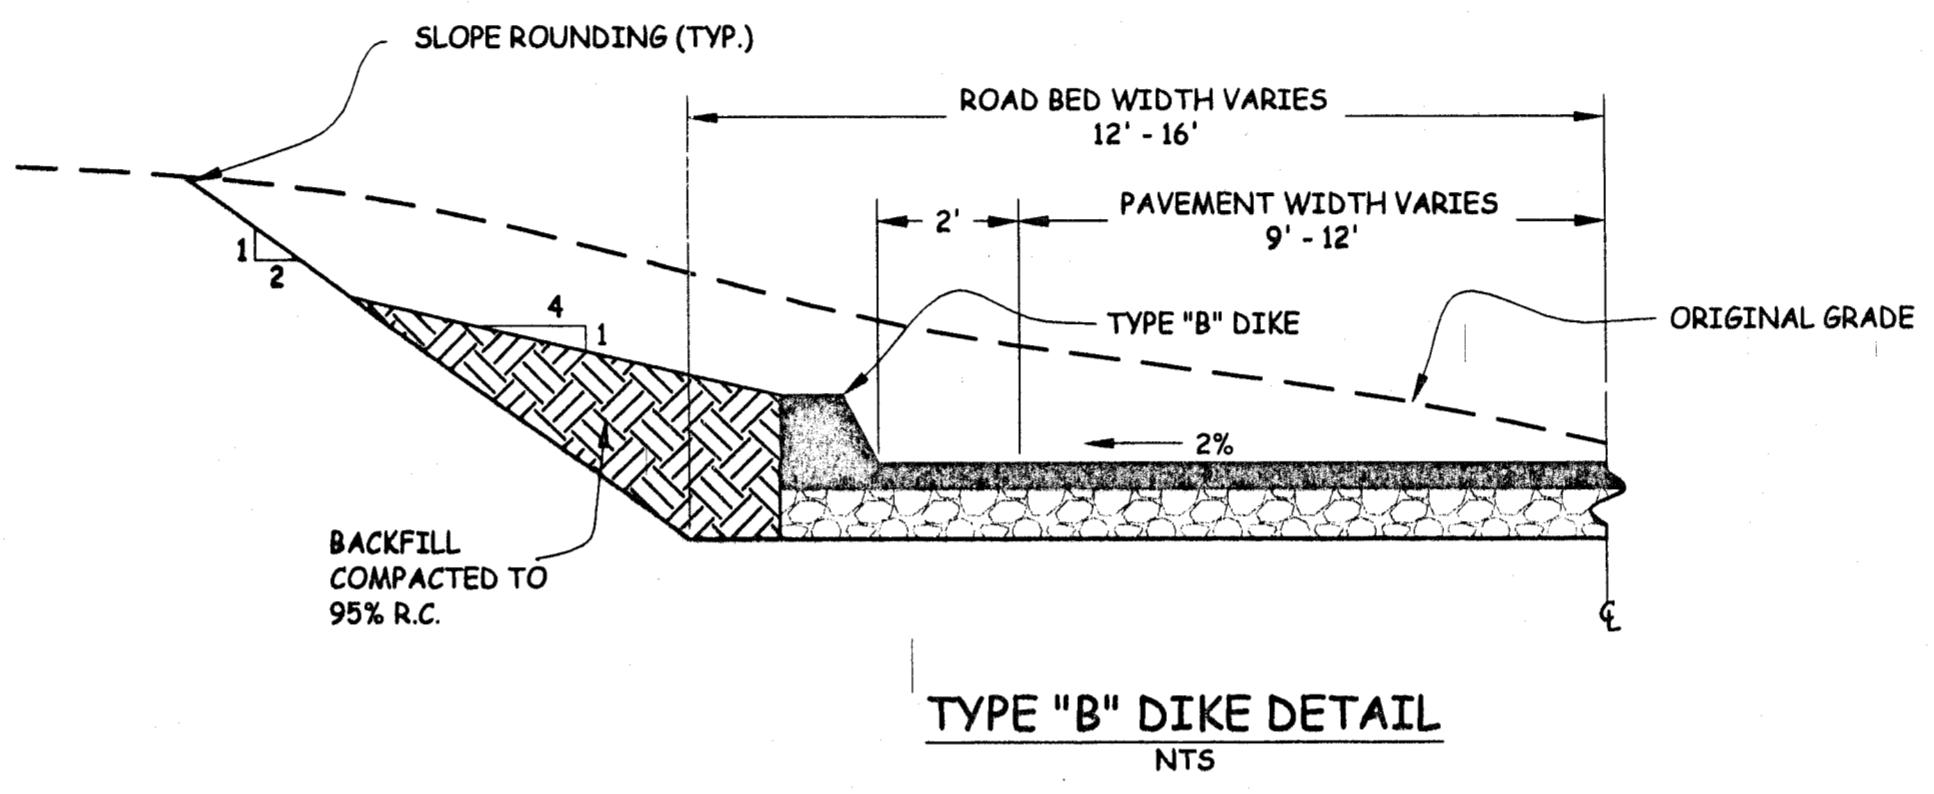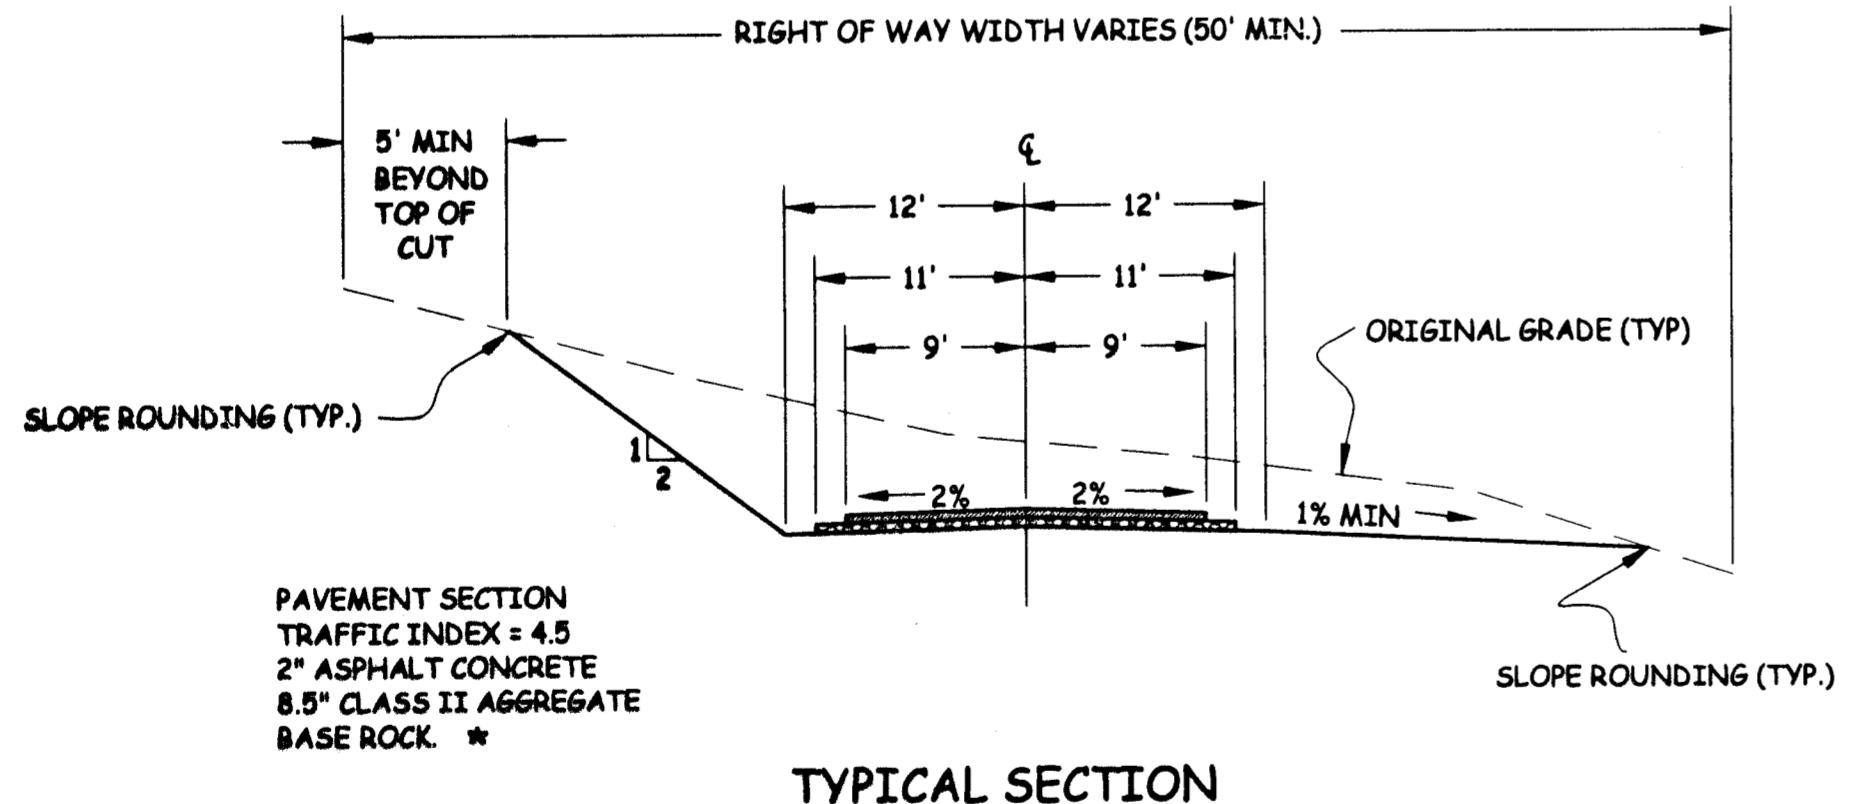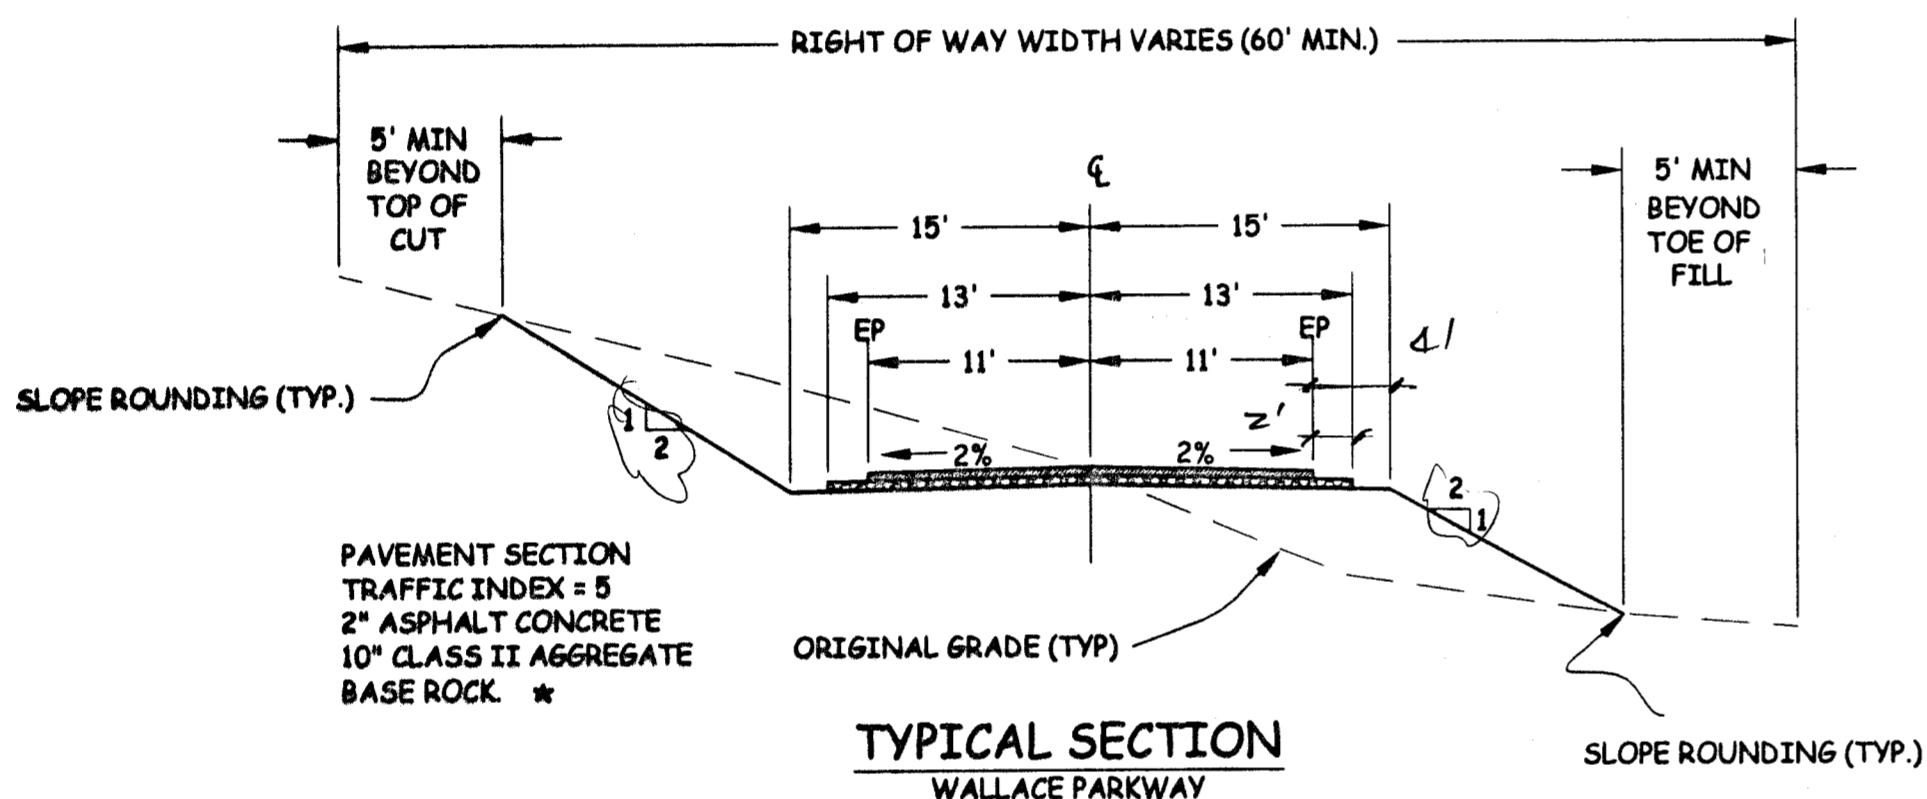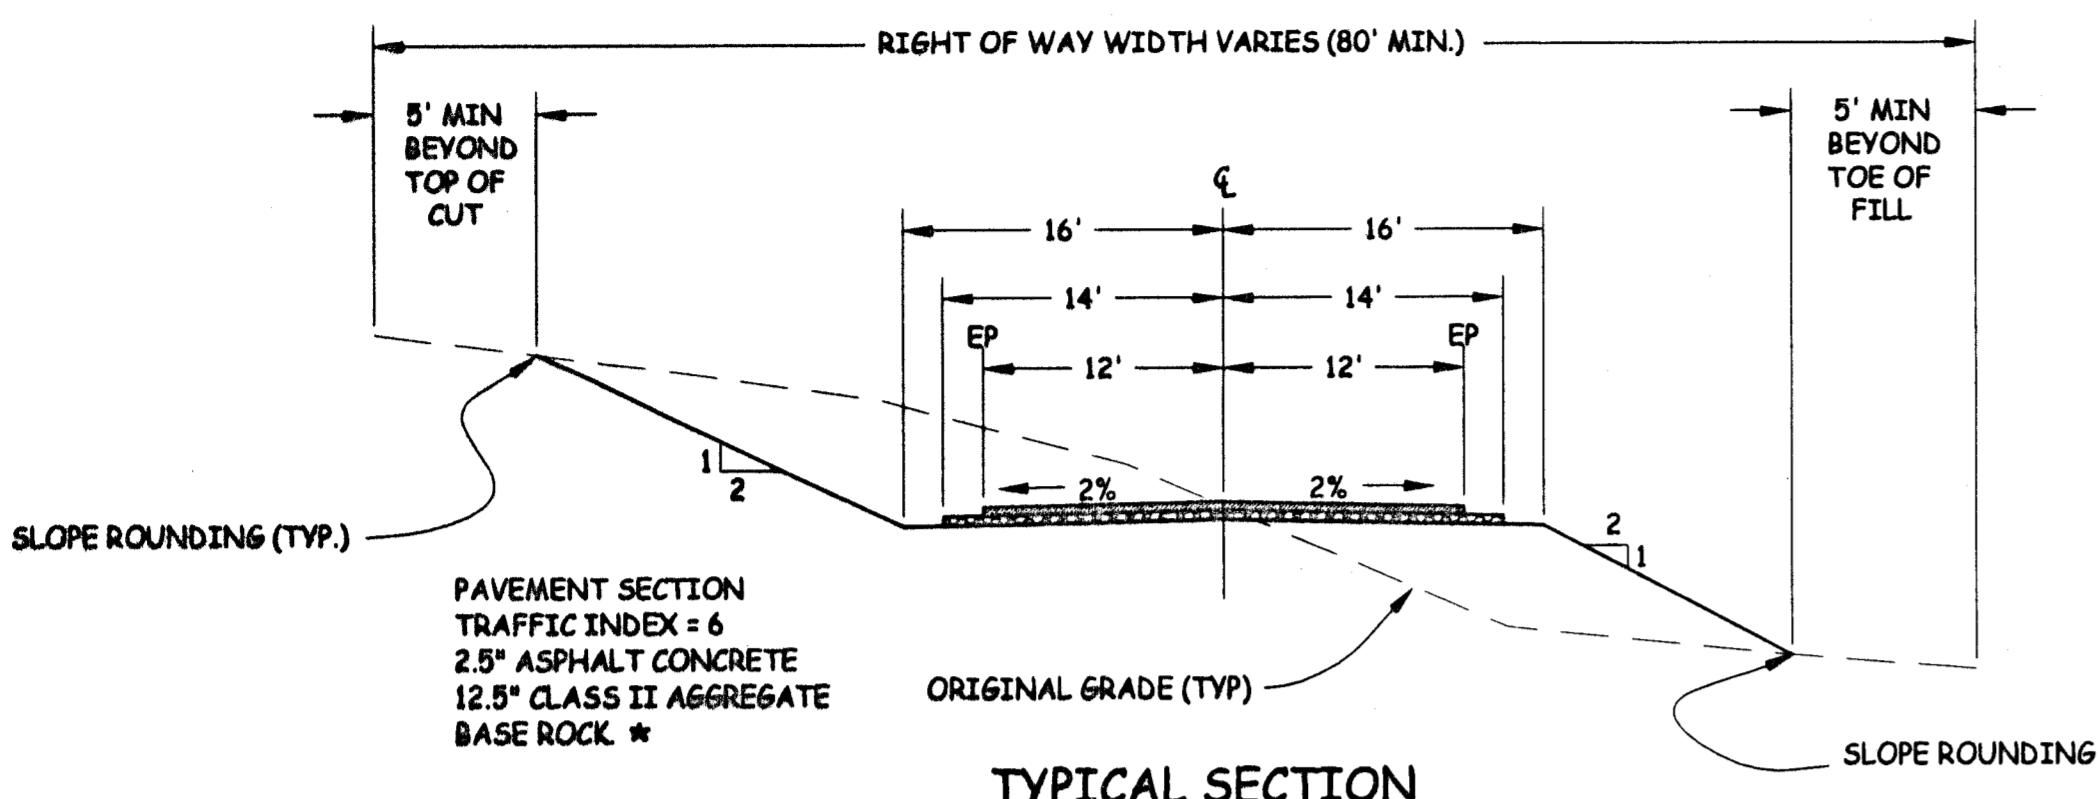
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					SCALE: AS NOTED	REGISTERED PROFESSIONAL ENGINEER BERNARD T. PEDERSEN No. 30759 03-31-04 CIVIL STATE OF CALIFORNIA *			
					DRAWN: RLS DESIGNED: TP CHECKED: TP				SHEET 2 OF 12



**GRADING PLAN
MOKE LUMINE OAKS
SUBDIVISION**

SHEET
3 of 12

A circular registration stamp. The outer ring contains the text "REGISTERED PROFESSIONAL ENGINEER" at the top and "BERNARD T. PEDERSEN" at the bottom. The inner circle contains "STATE OF CALIFORNIA" at the top and "CIVIL" at the bottom. In the center, it says "NO. 30759" and "EXP. 03-31-05".



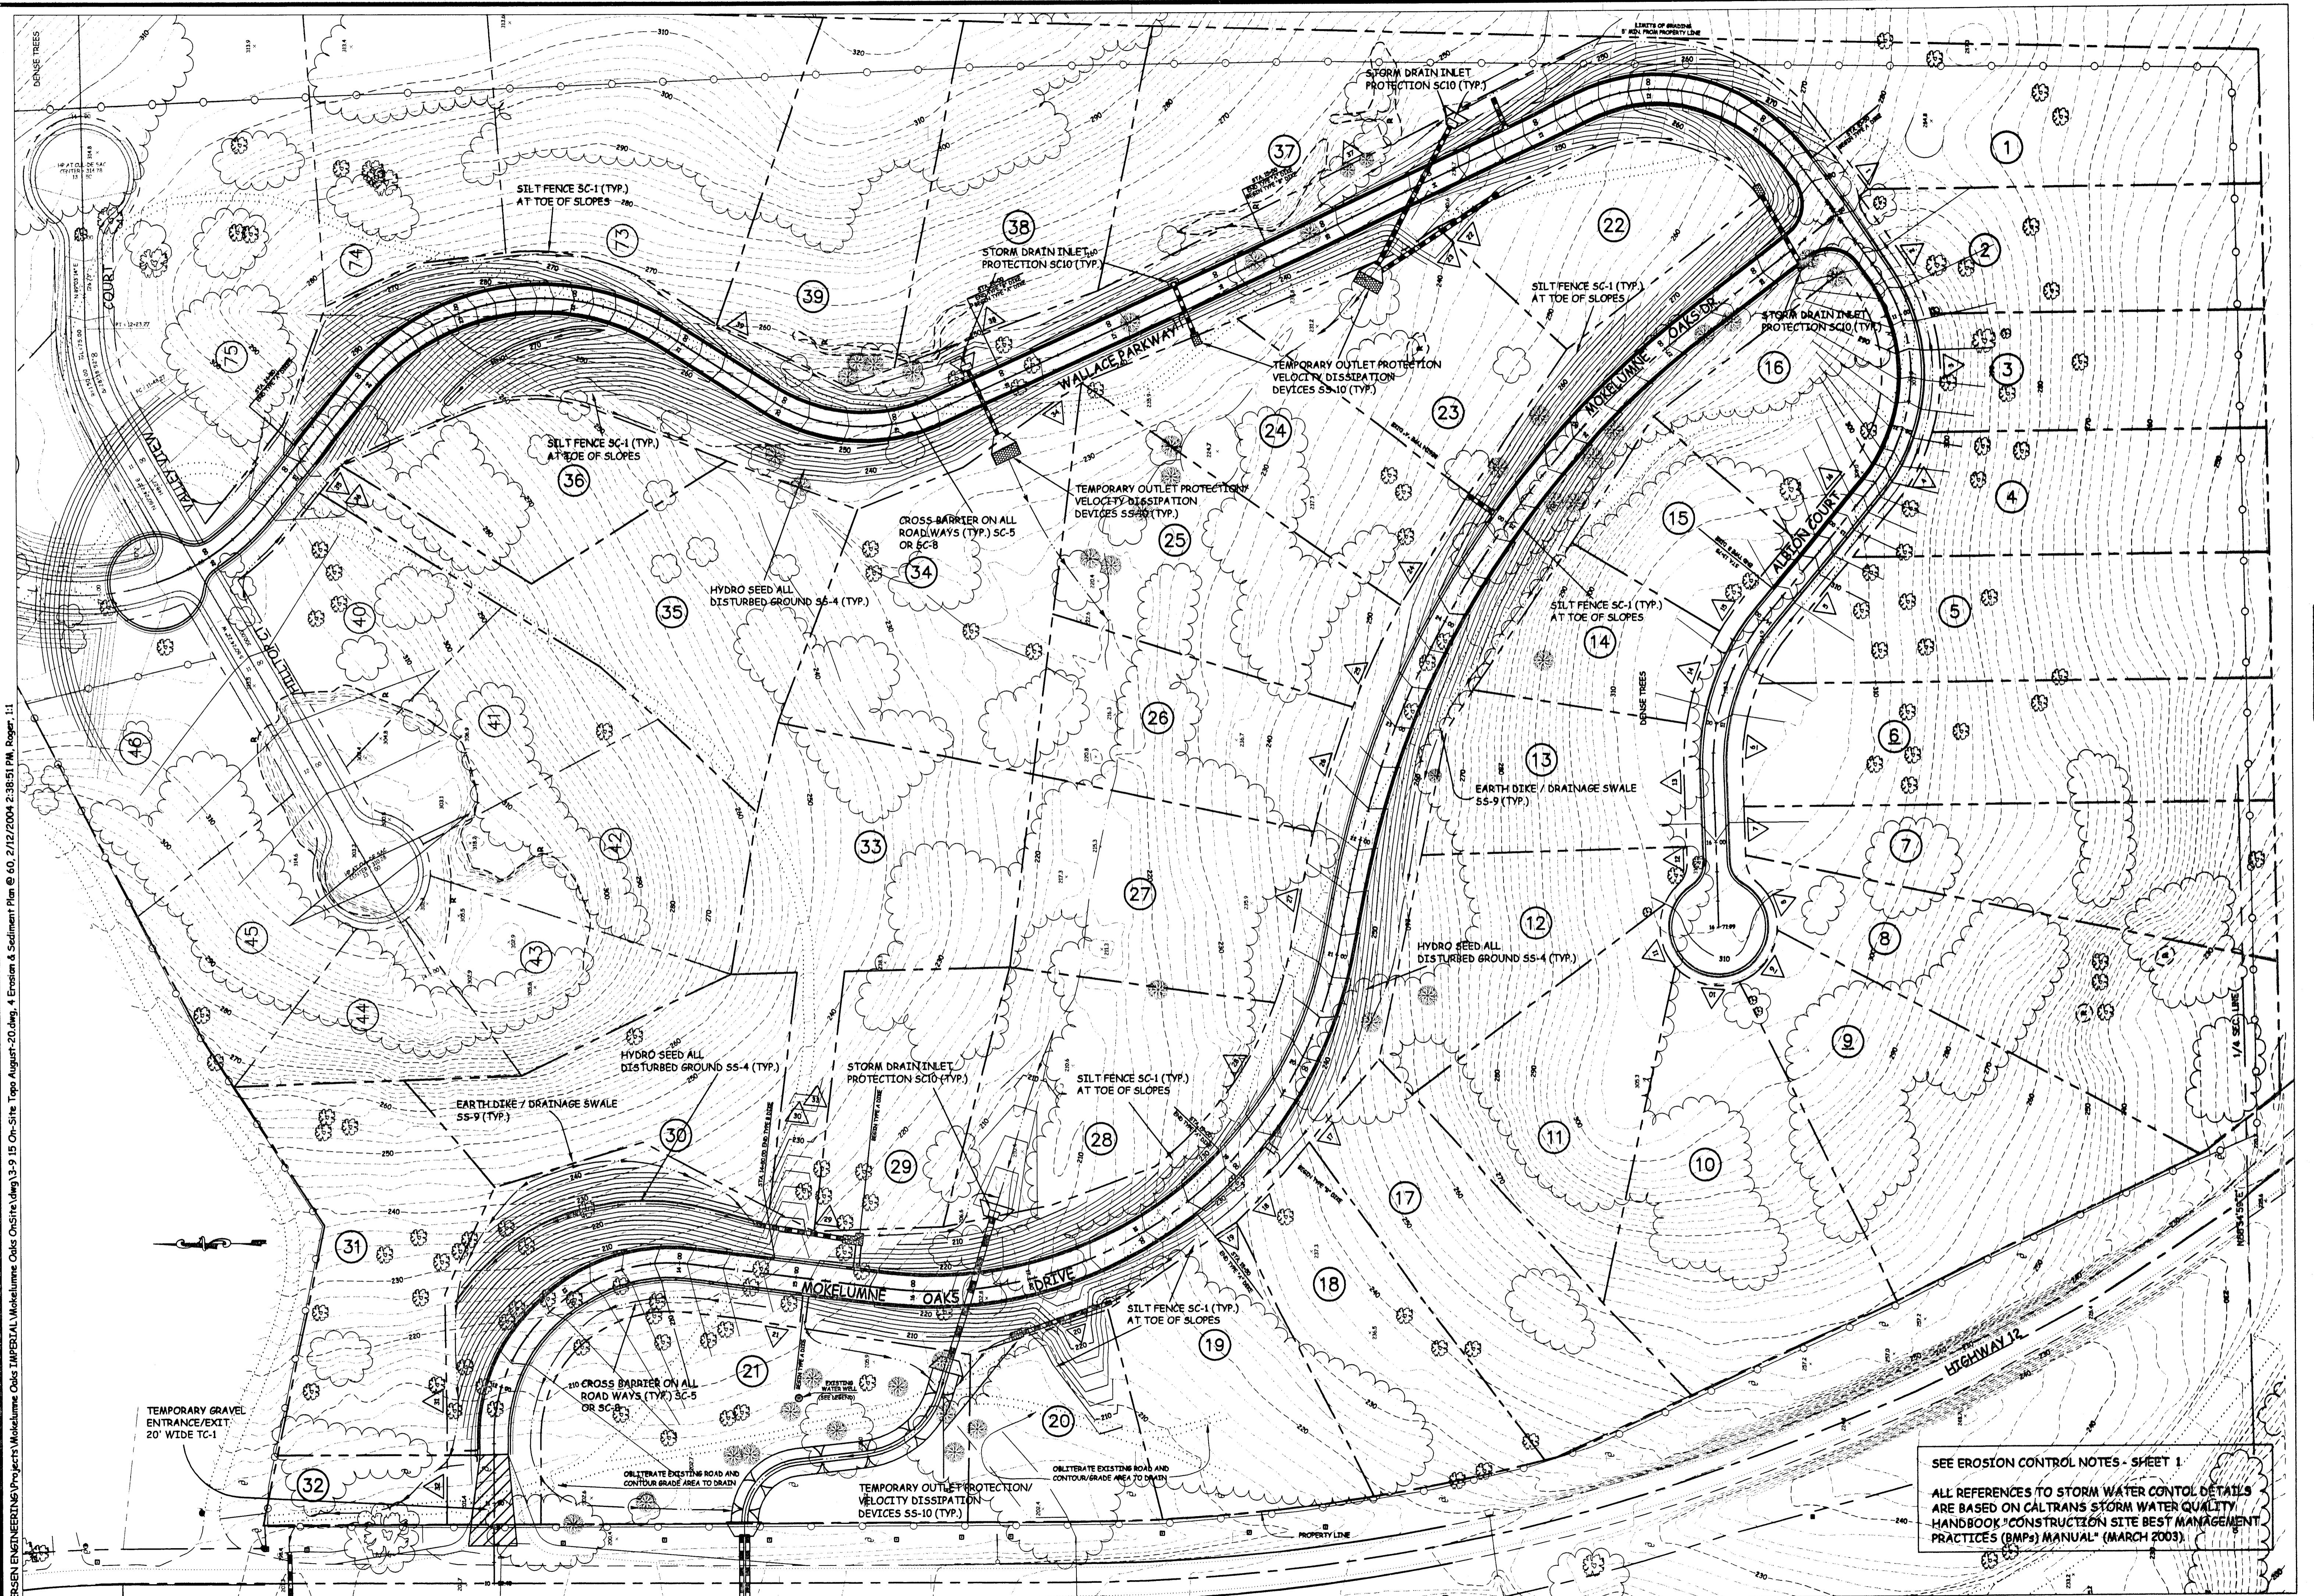


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**STON & SEDIMENT CONTROL P
MOKELUMNE OAKS
SUBDIVISION**


Erosion Control Notes - Sheet 1

ALL REFERENCES TO STORM WATER CONTROL DETAILS
ARE BASED ON CALTRANS STORM WATER QUALITY
HANDBOOK "CONSTRUCTION SITE BEST MANAGEMENT
PRACTICES (BMPs) MANUAL" (MARCH 2003).
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APPROVED BY:	DATE: 8/28/03	PREPARED UNDER THE DIRECTION OF:
	SCALE: 1"=40'H/1"=4'V	<u>Bernard T. Pedersen</u> 2/13/04
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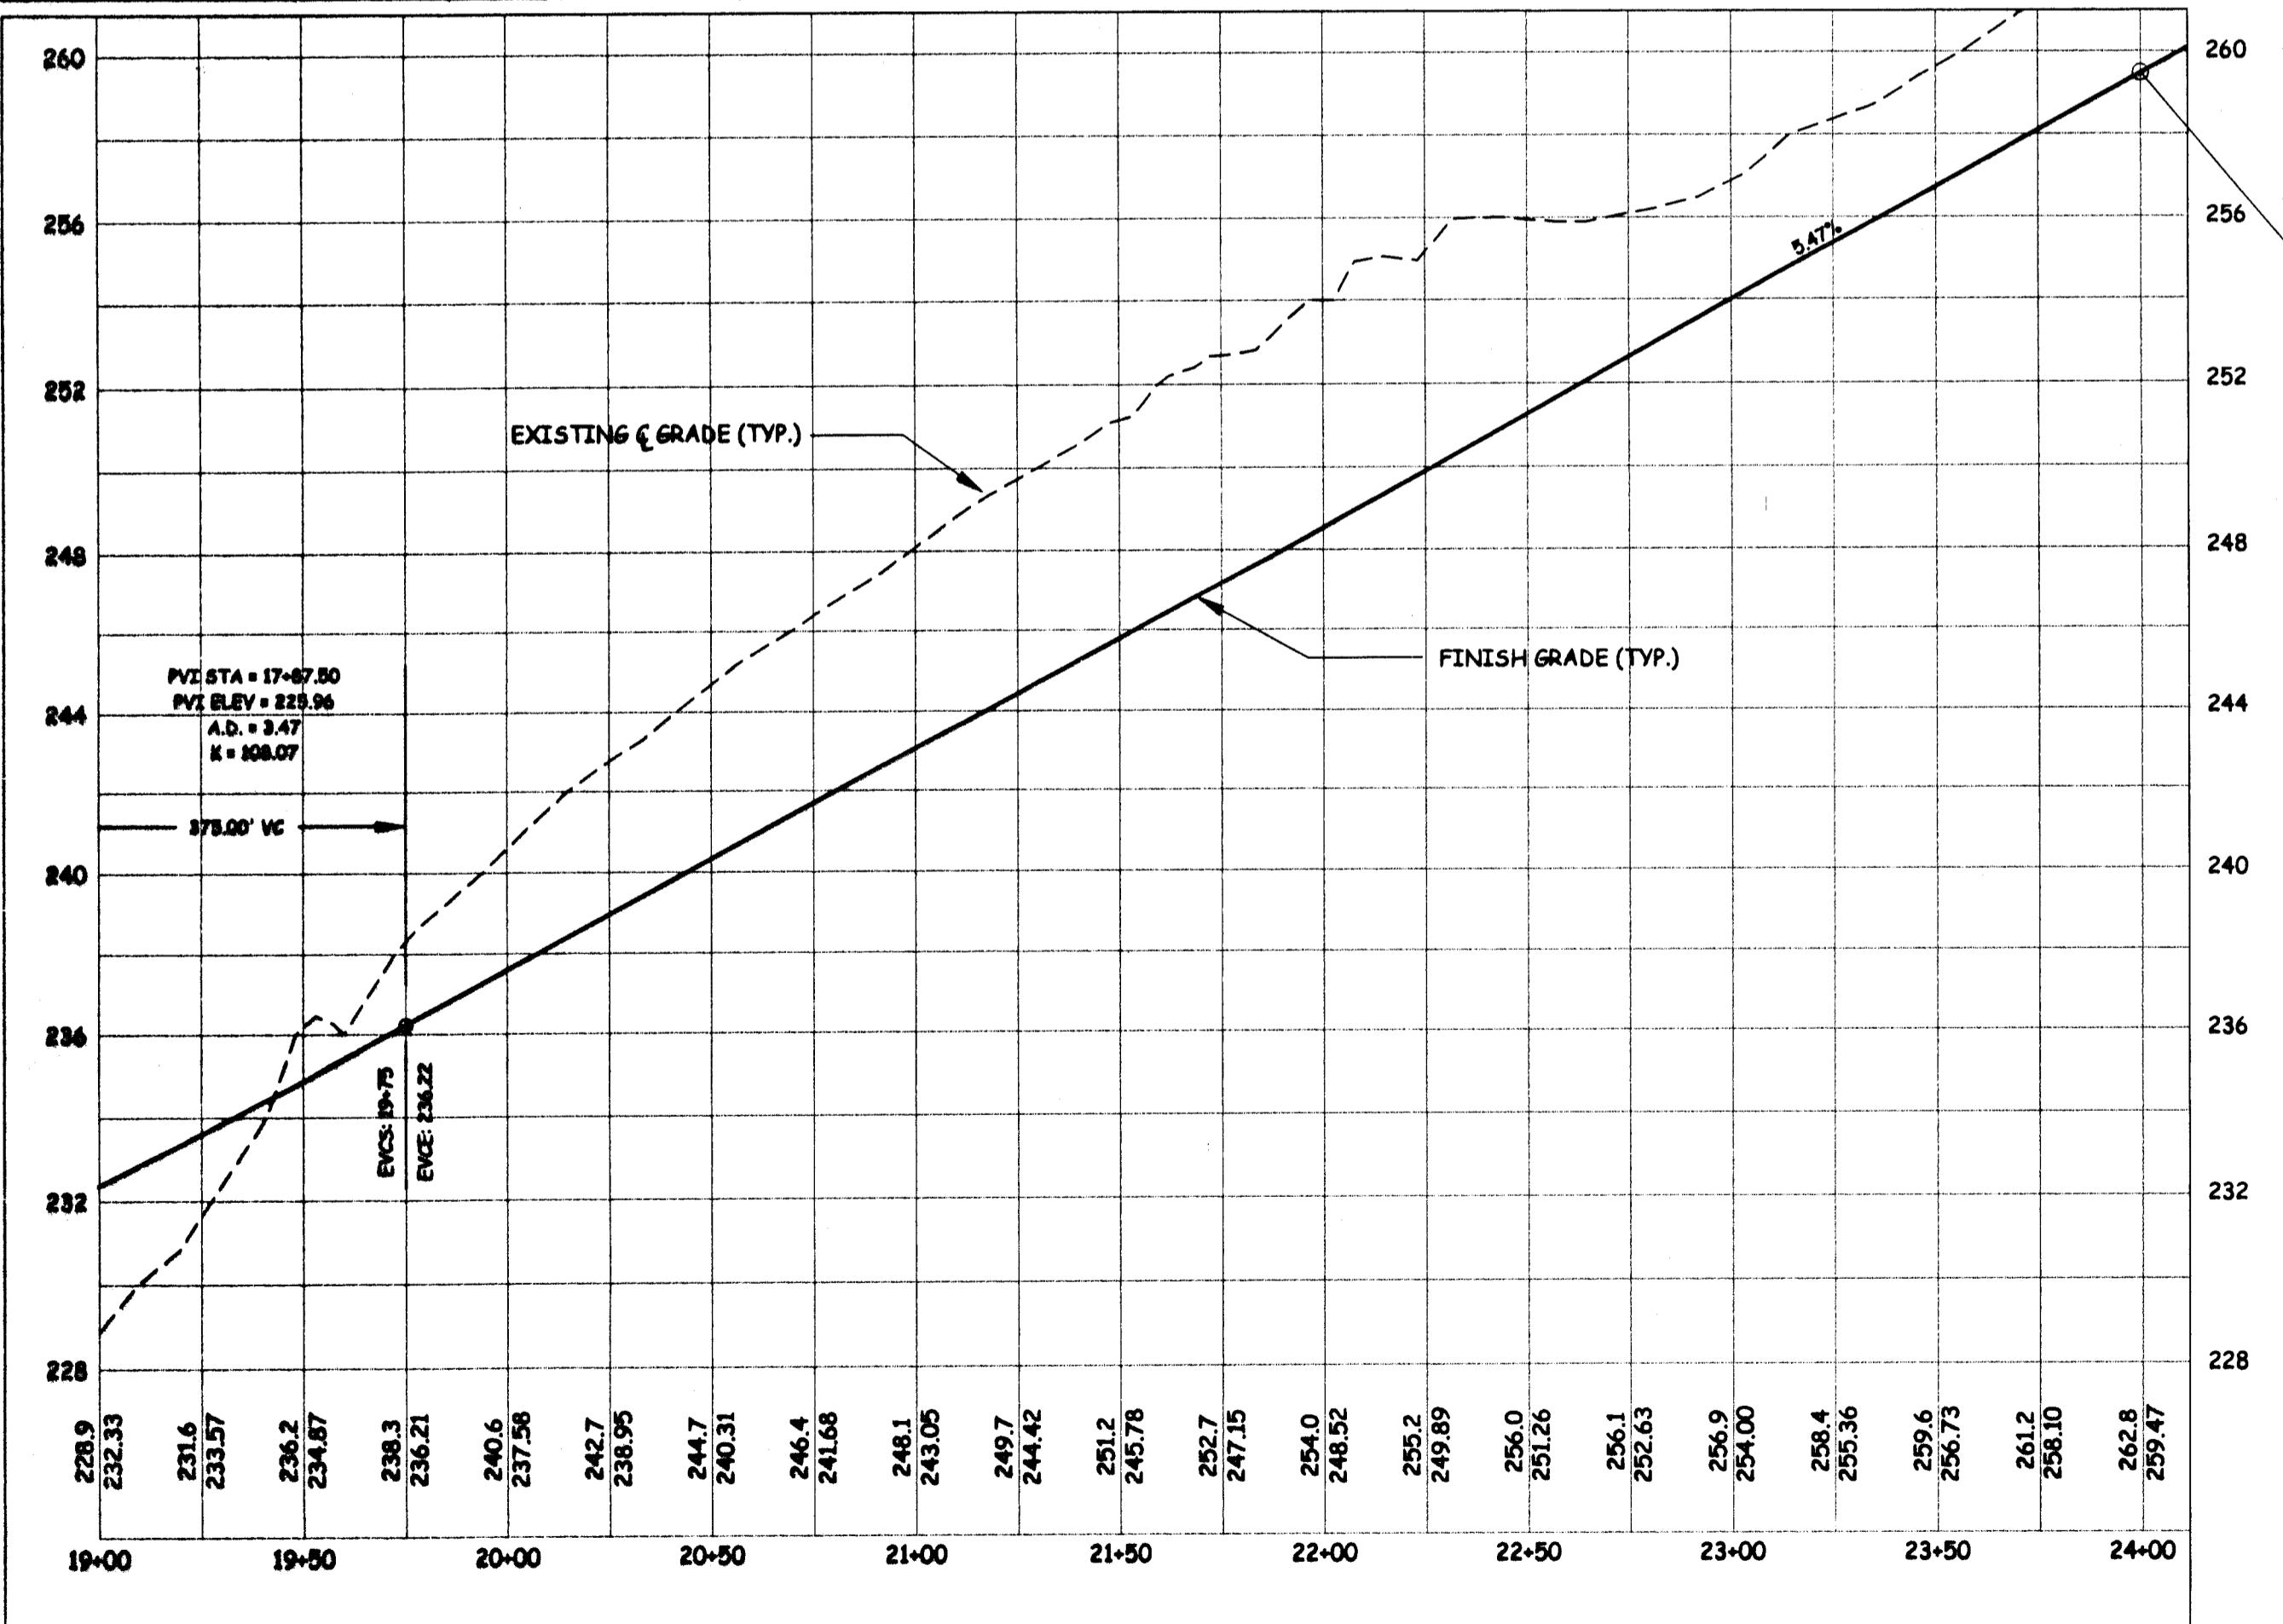
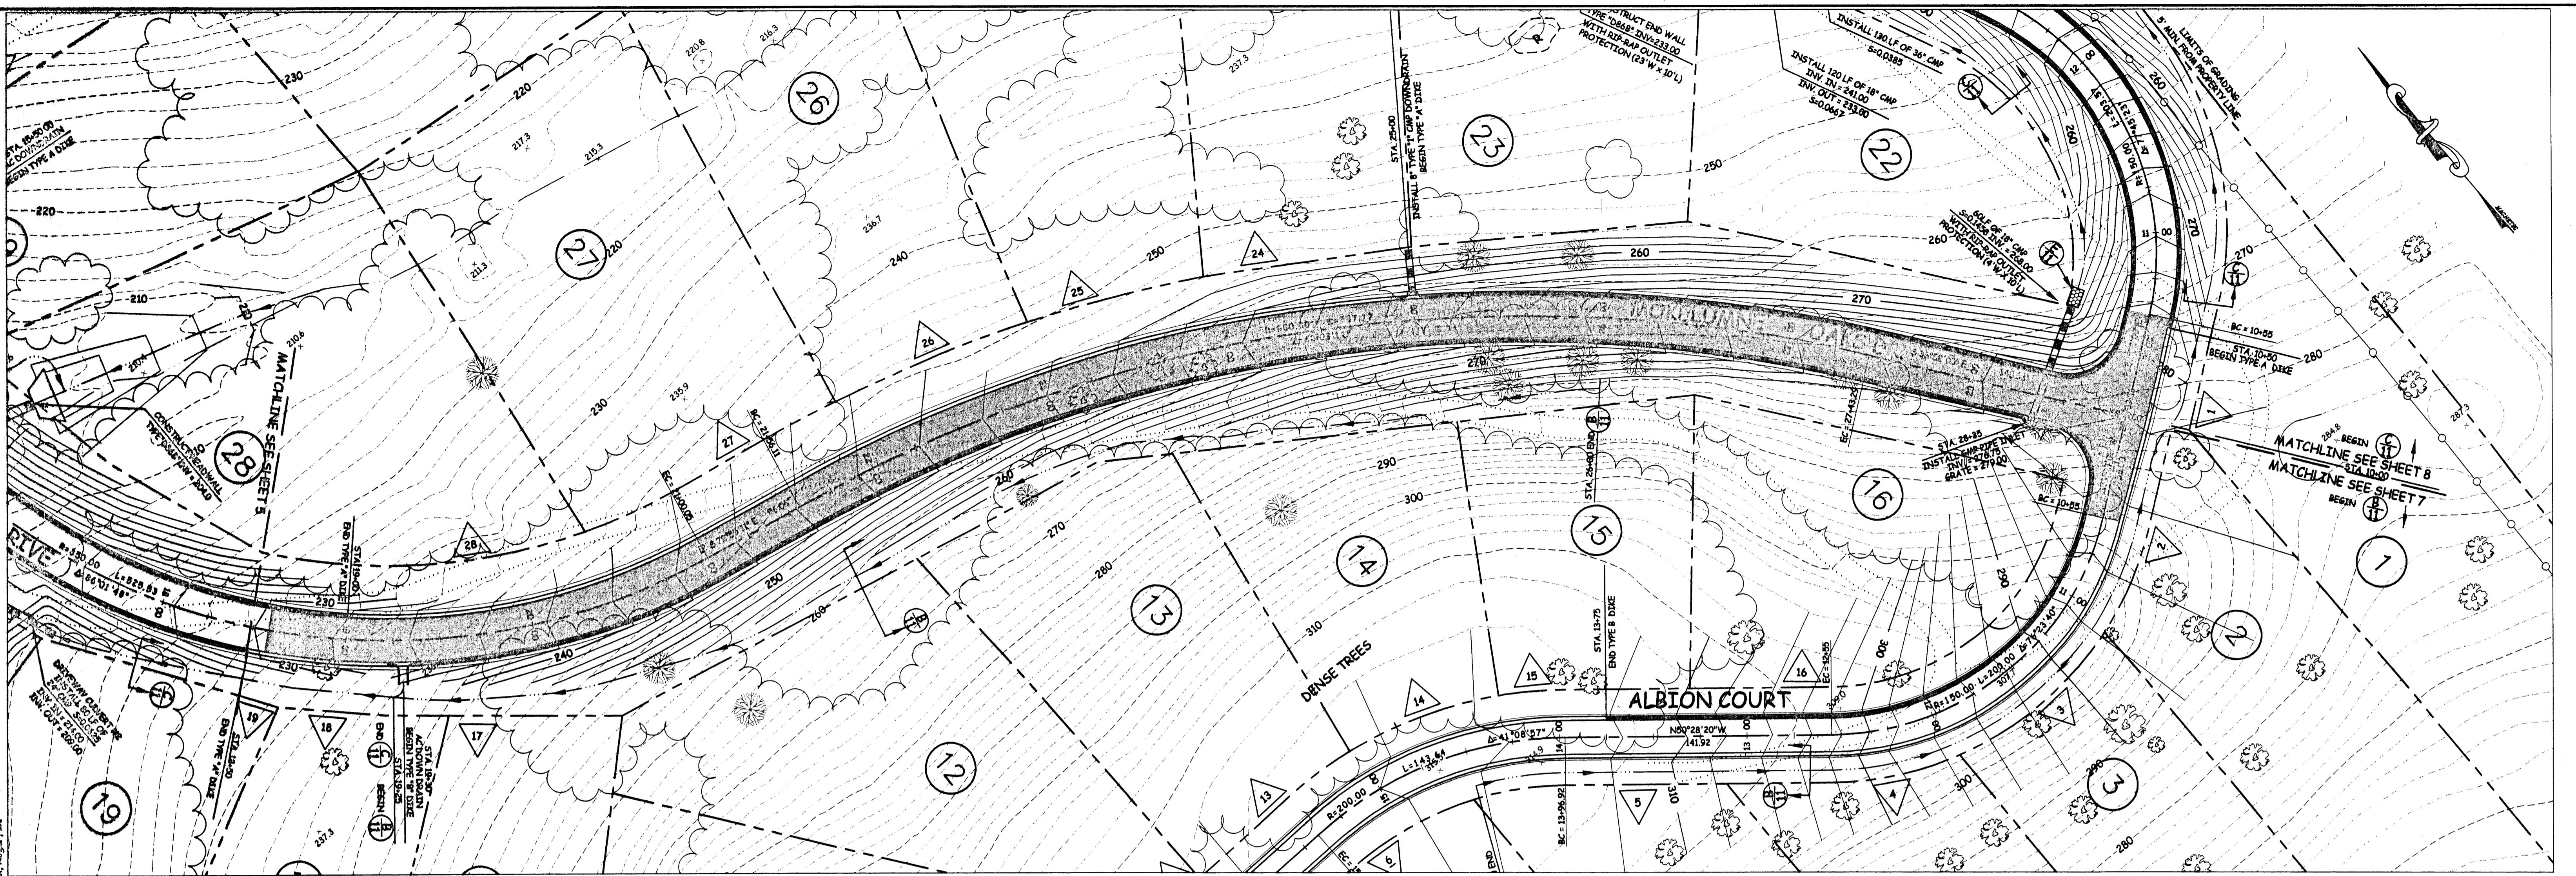
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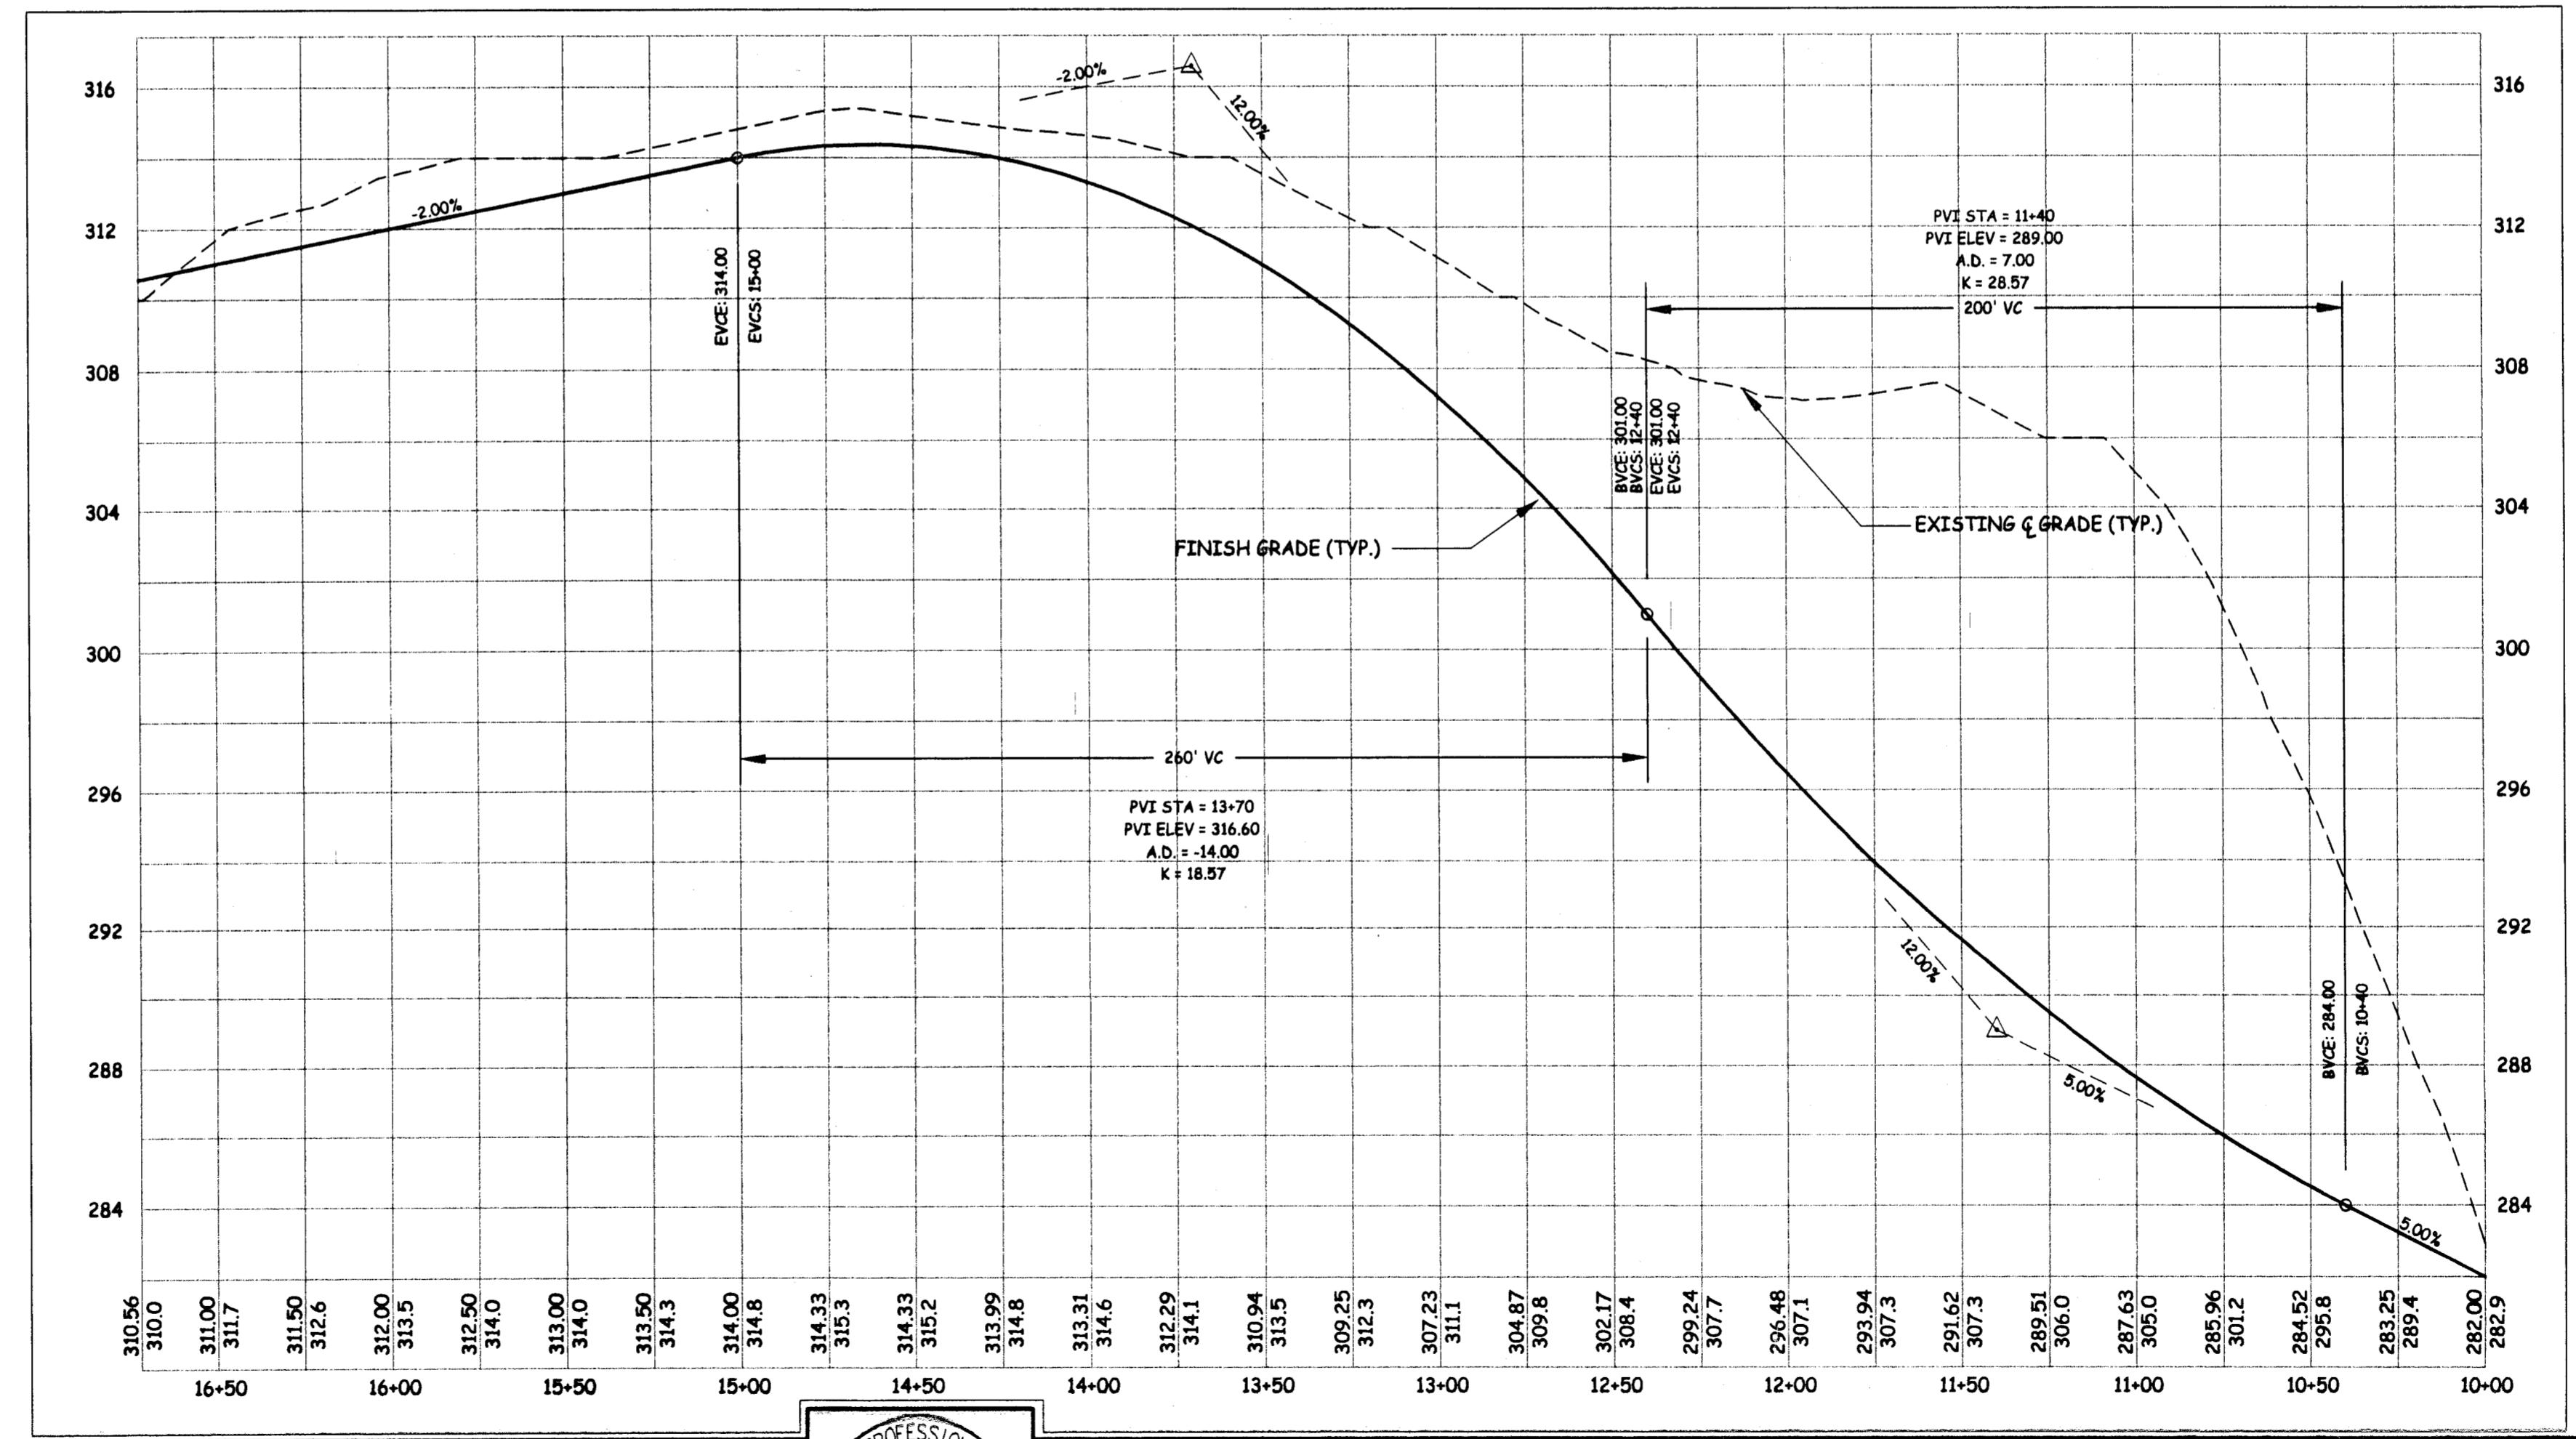
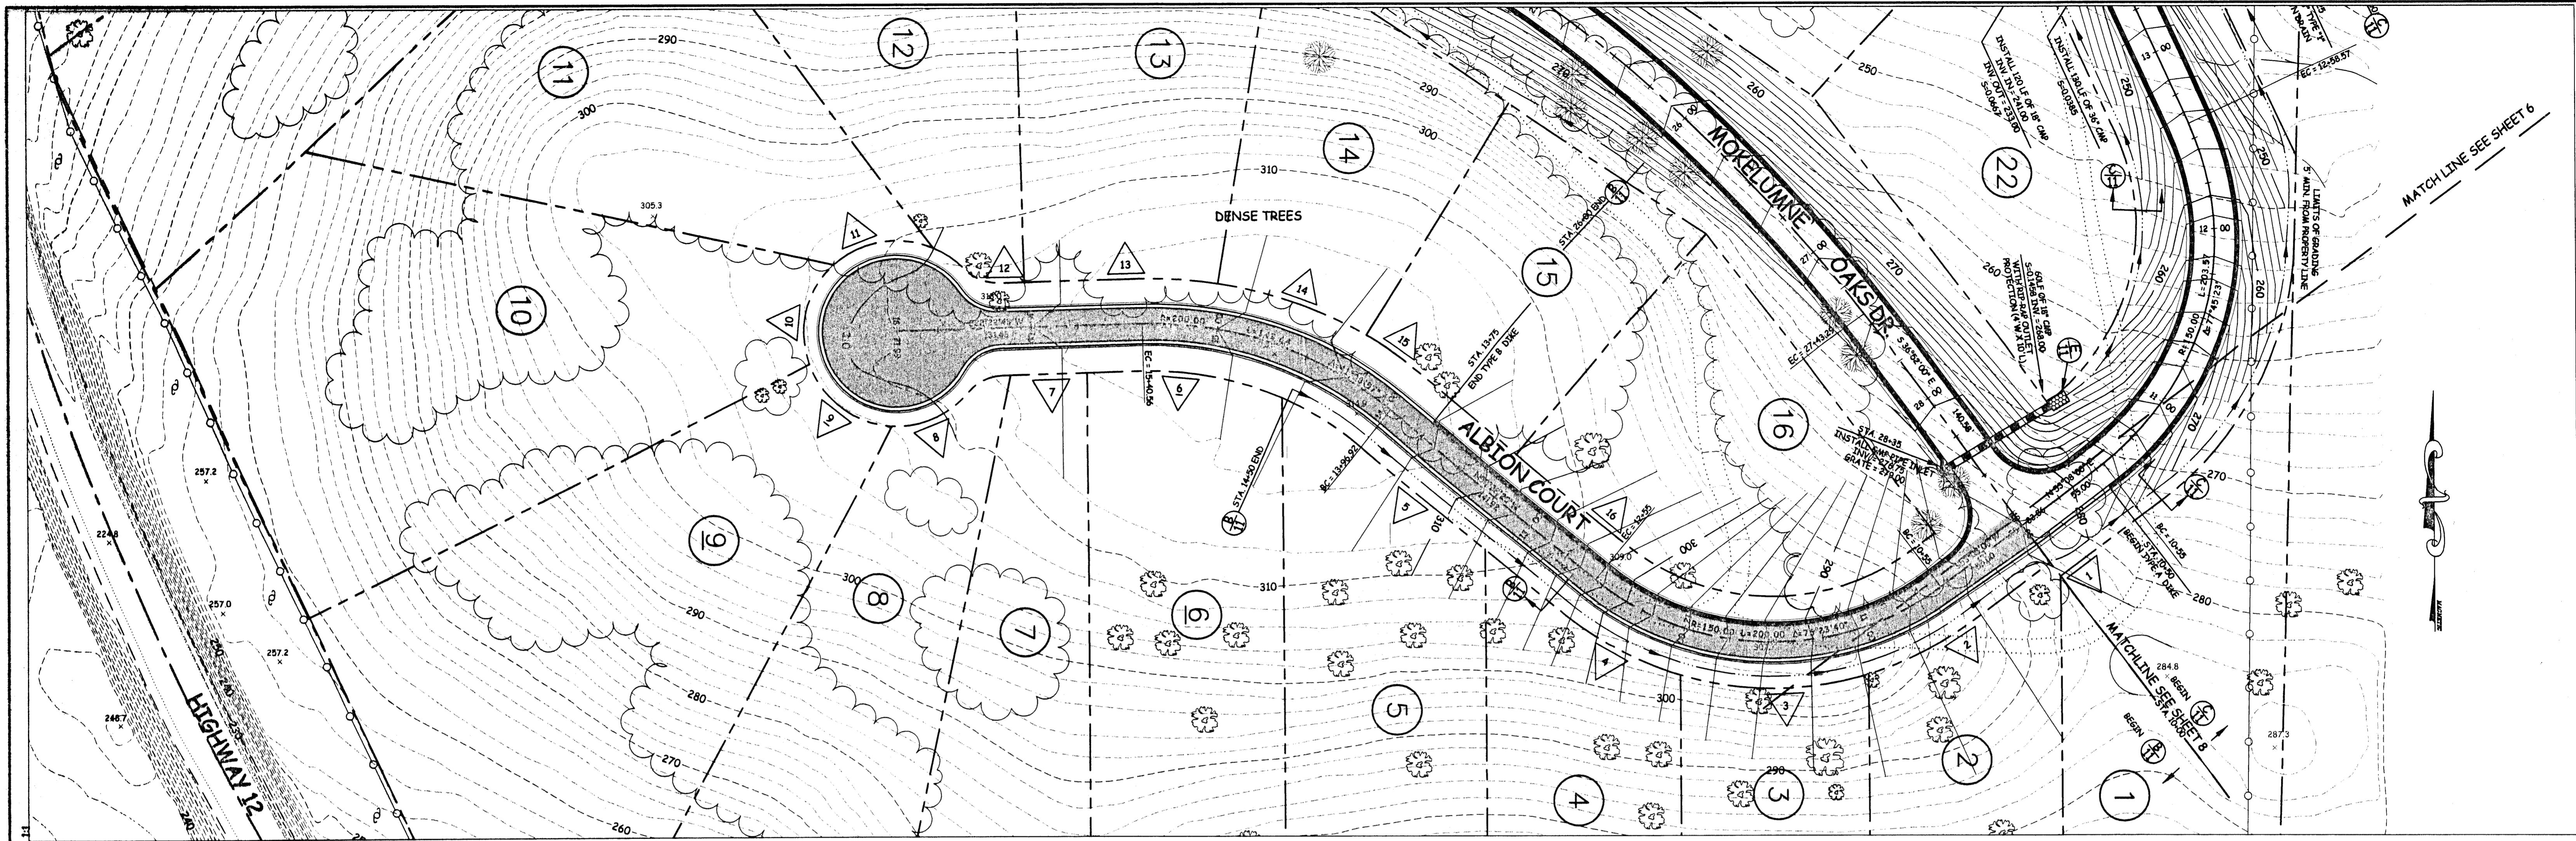
MOKELUMNE OAKS SUBDIVISION

PROJECT # 0206-22

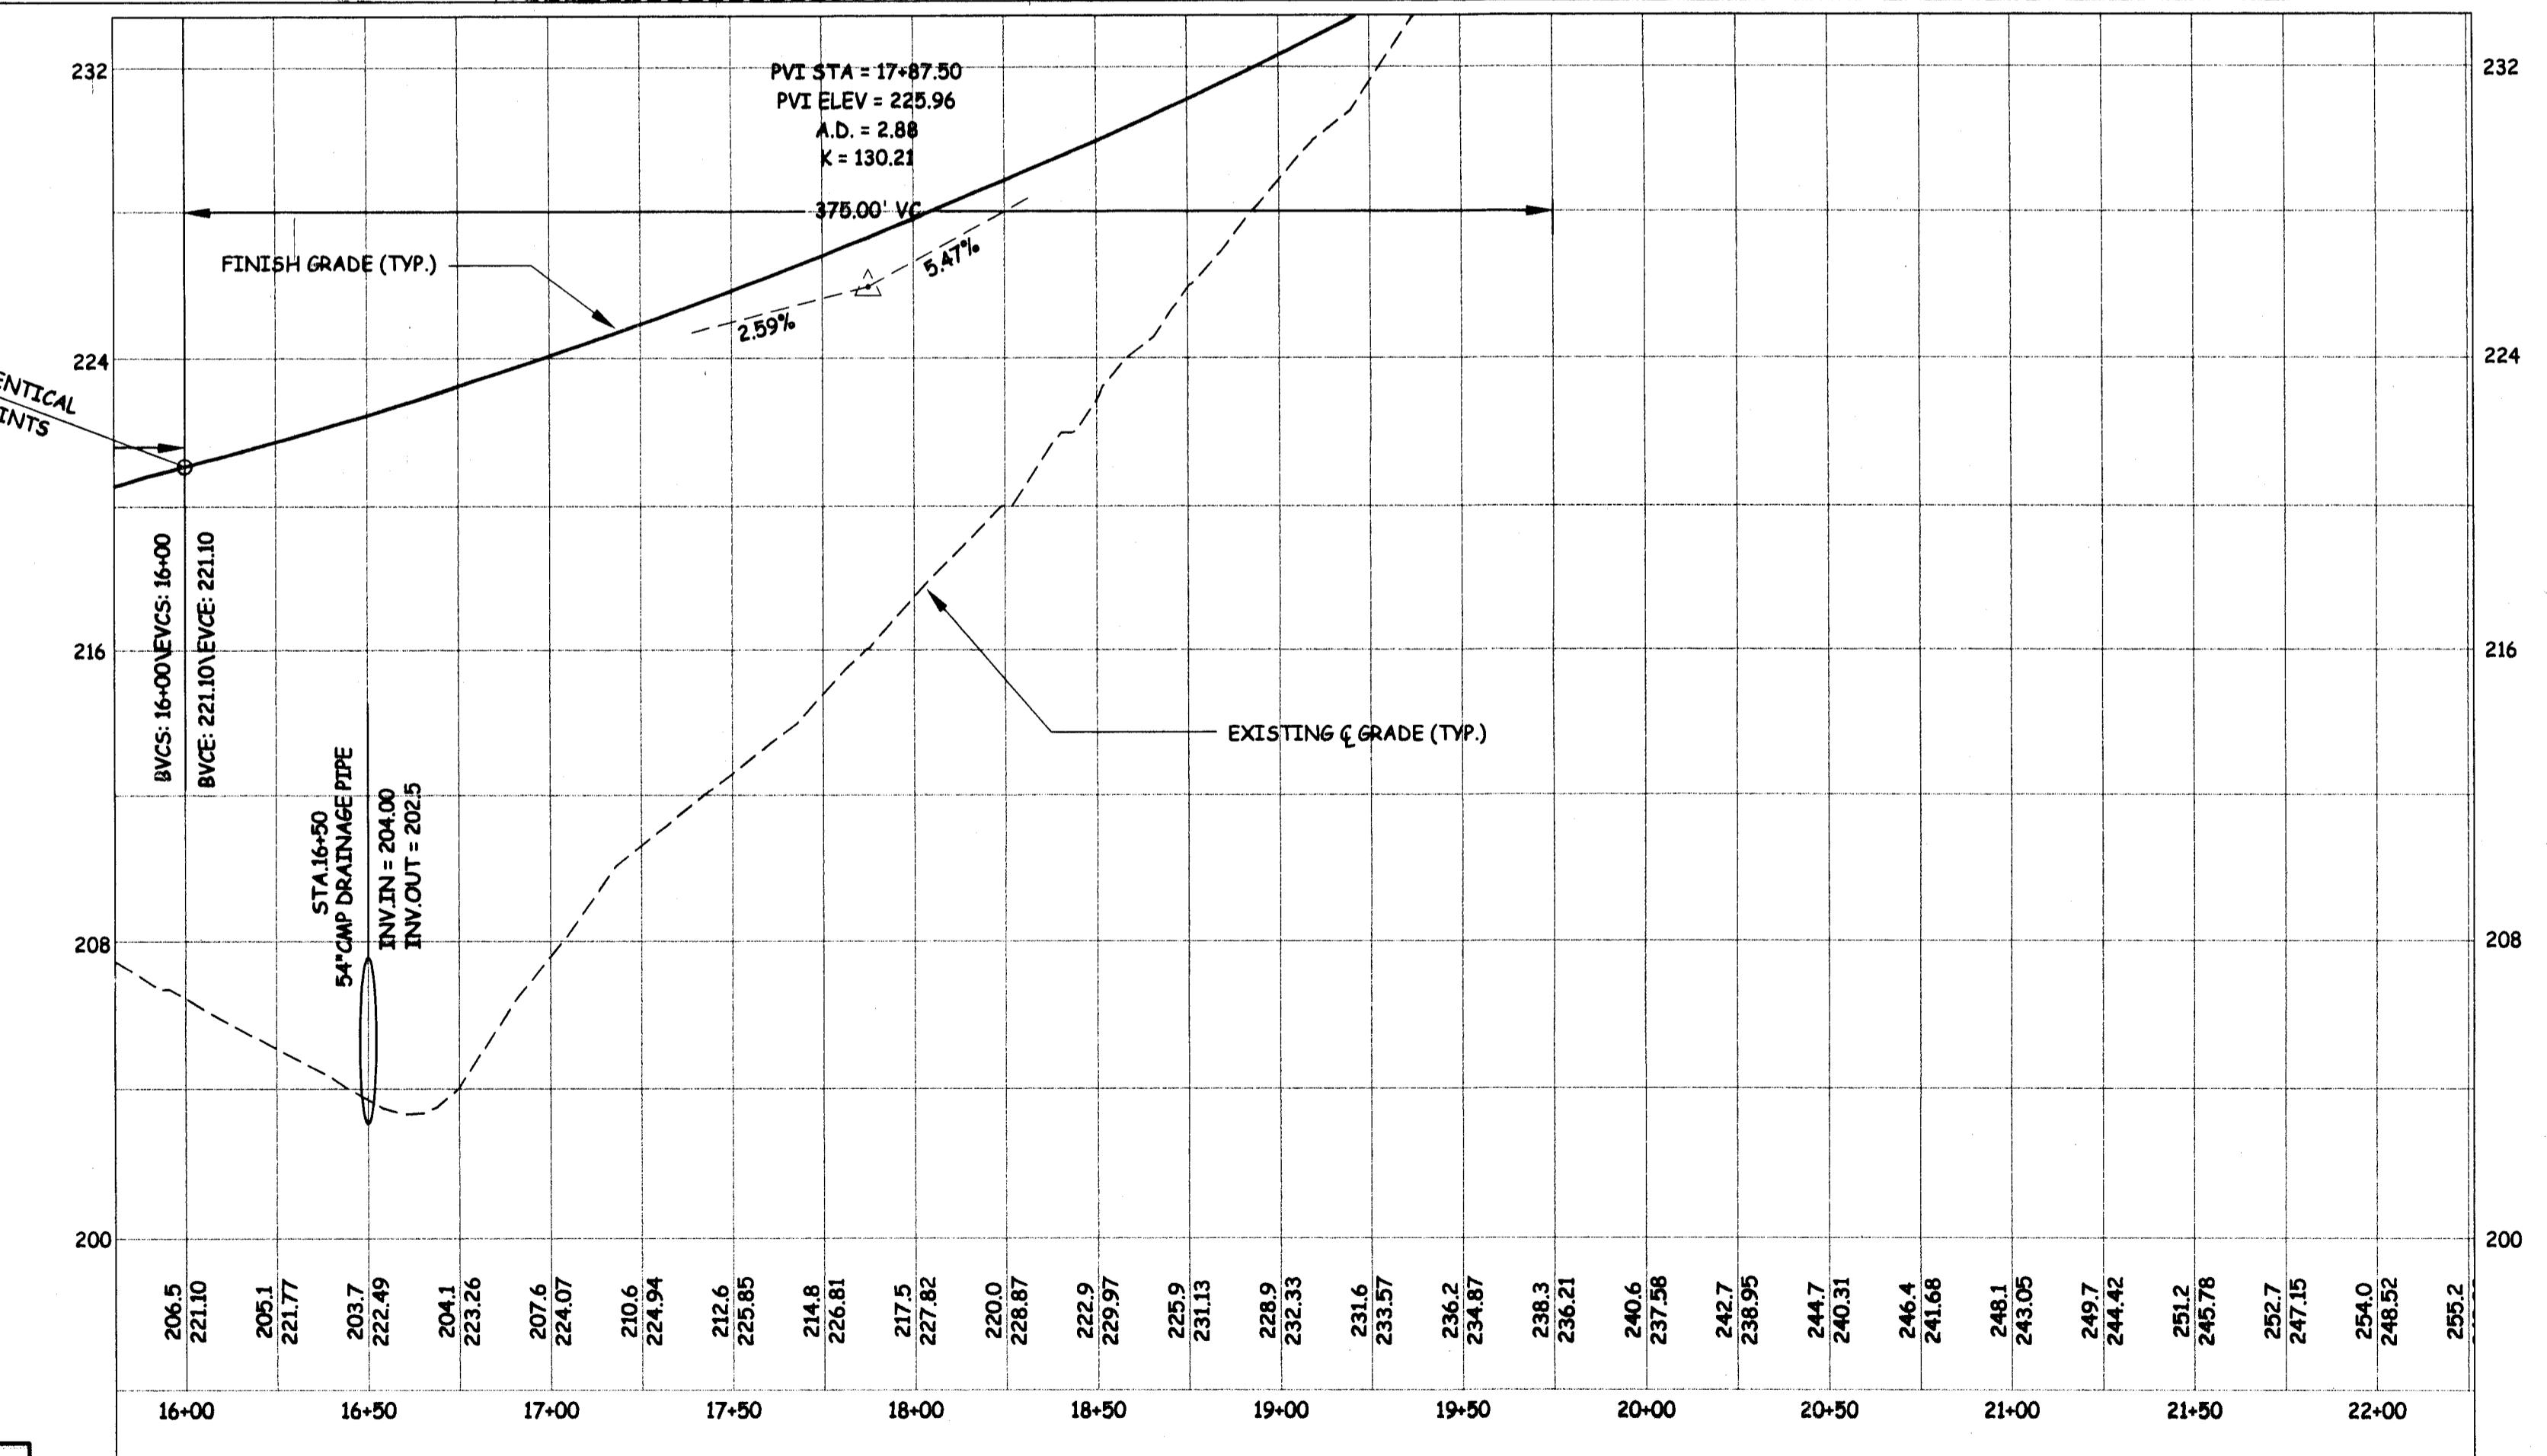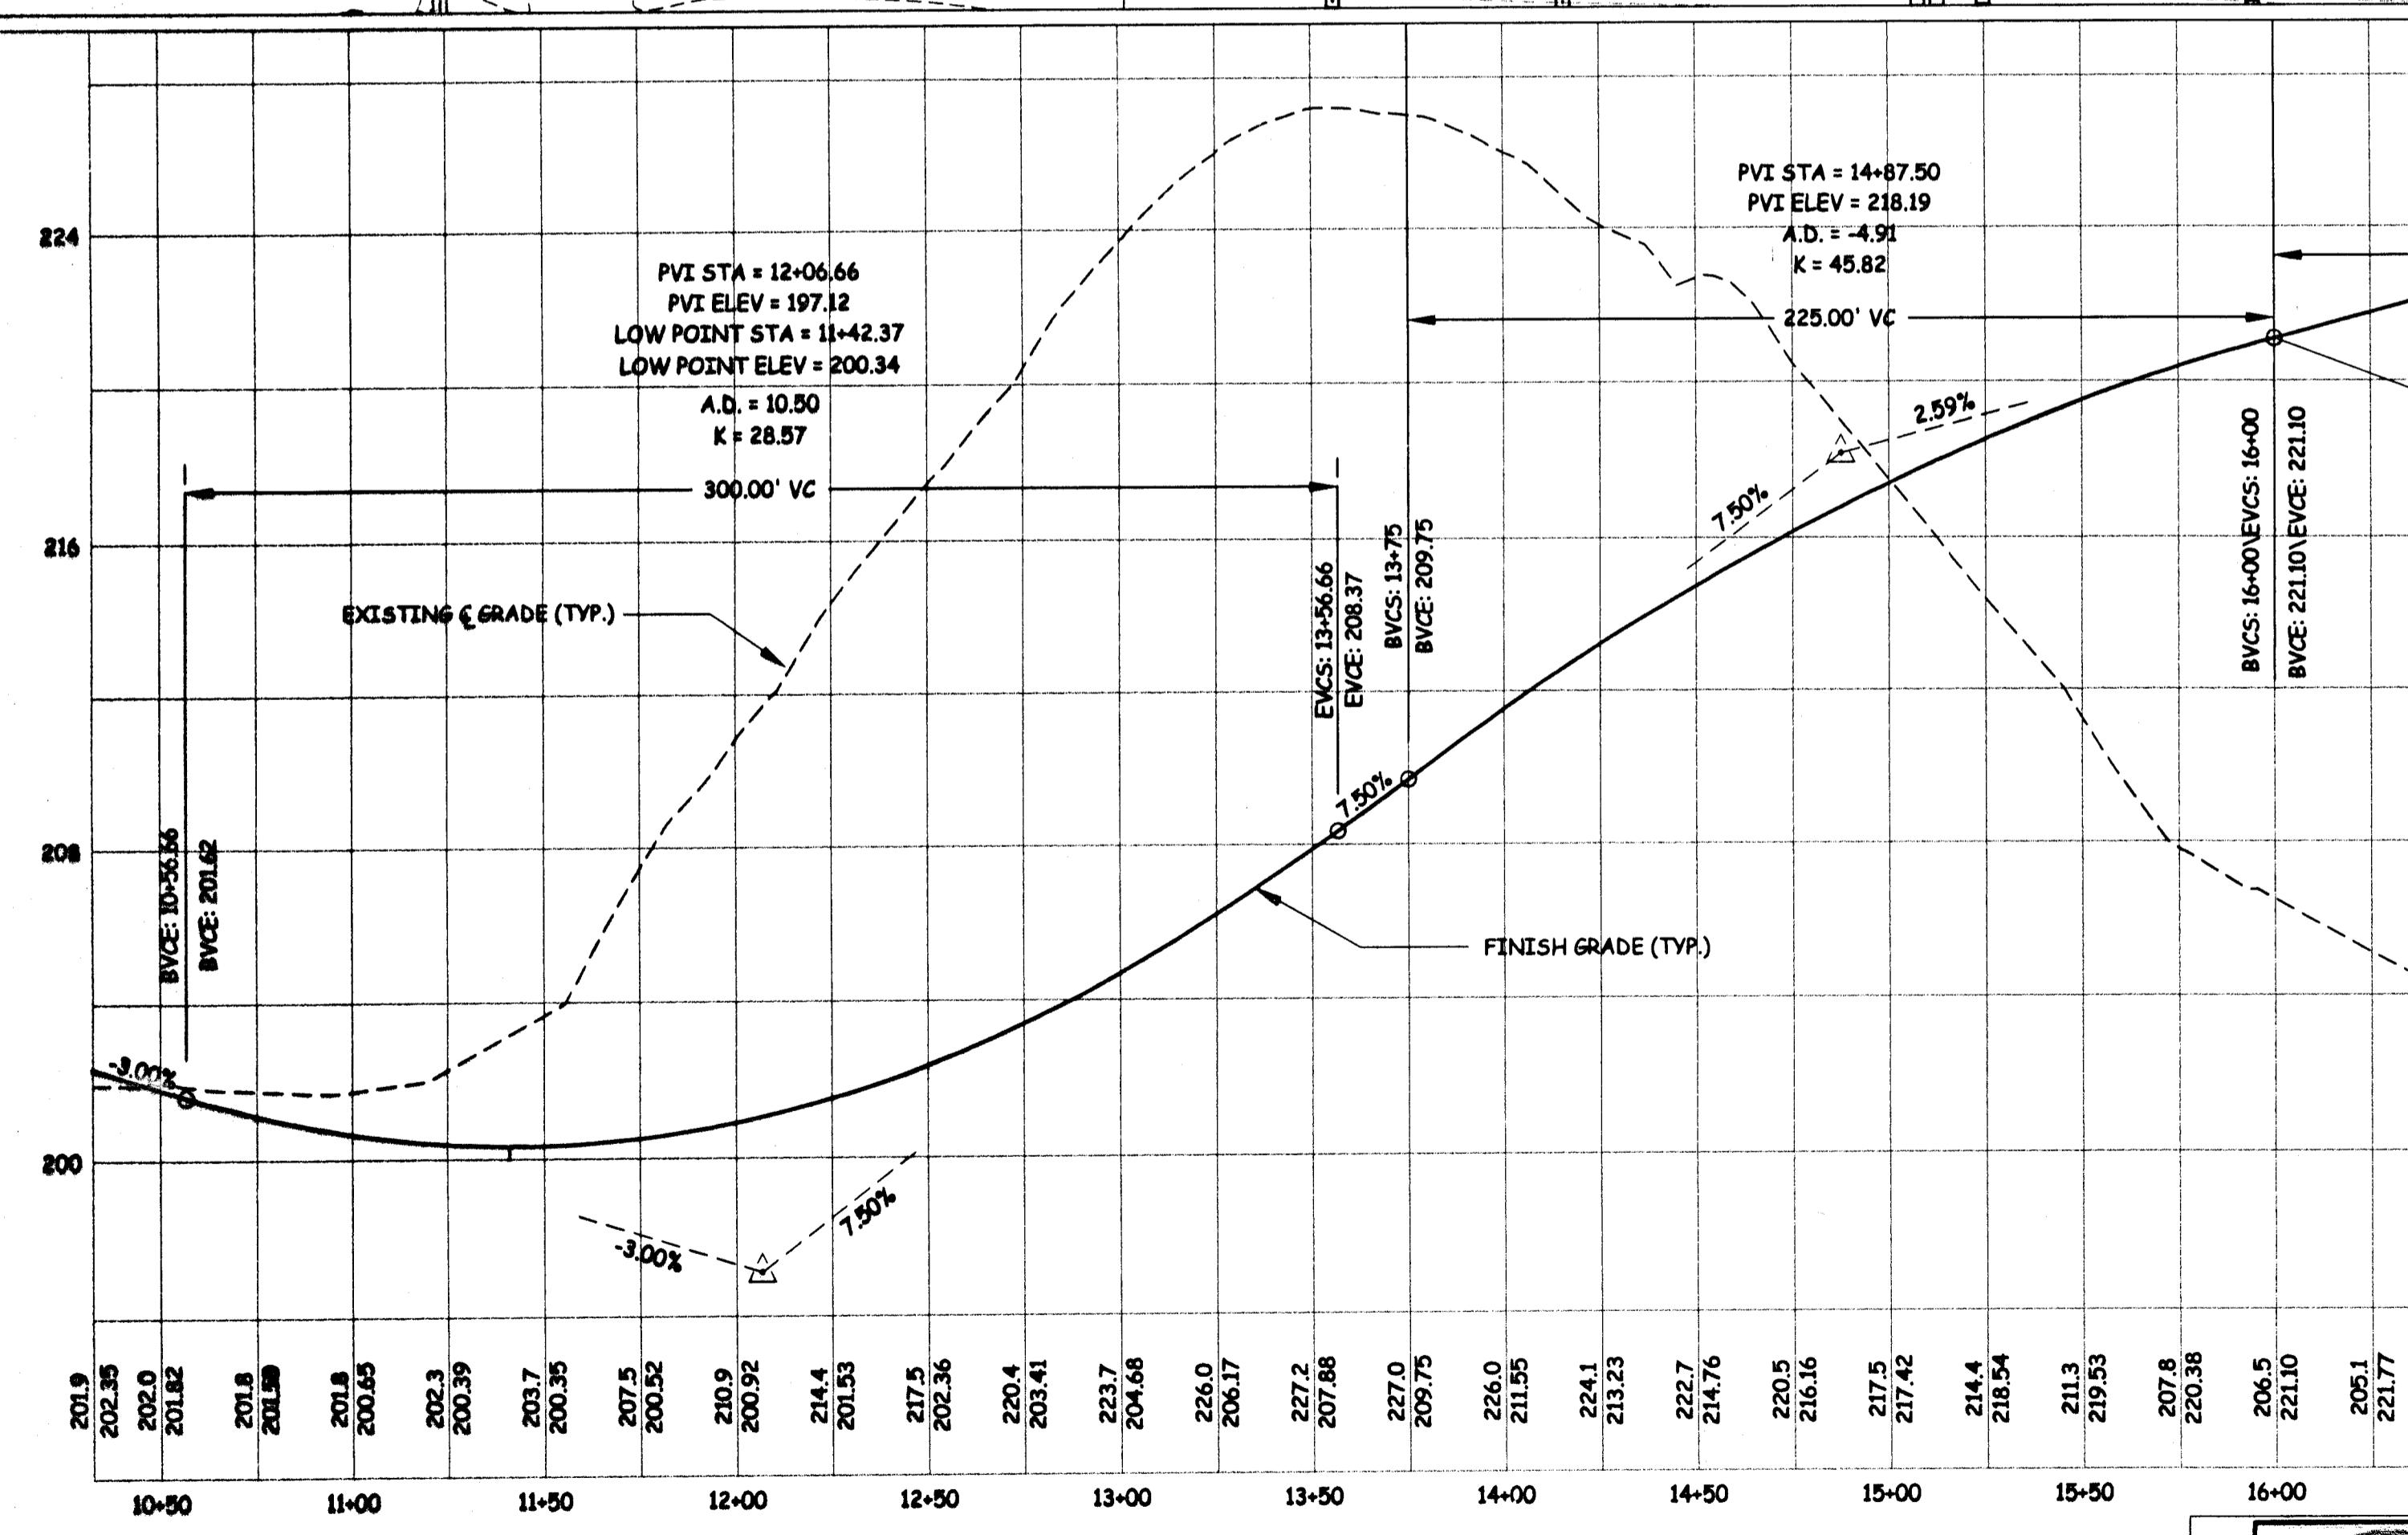
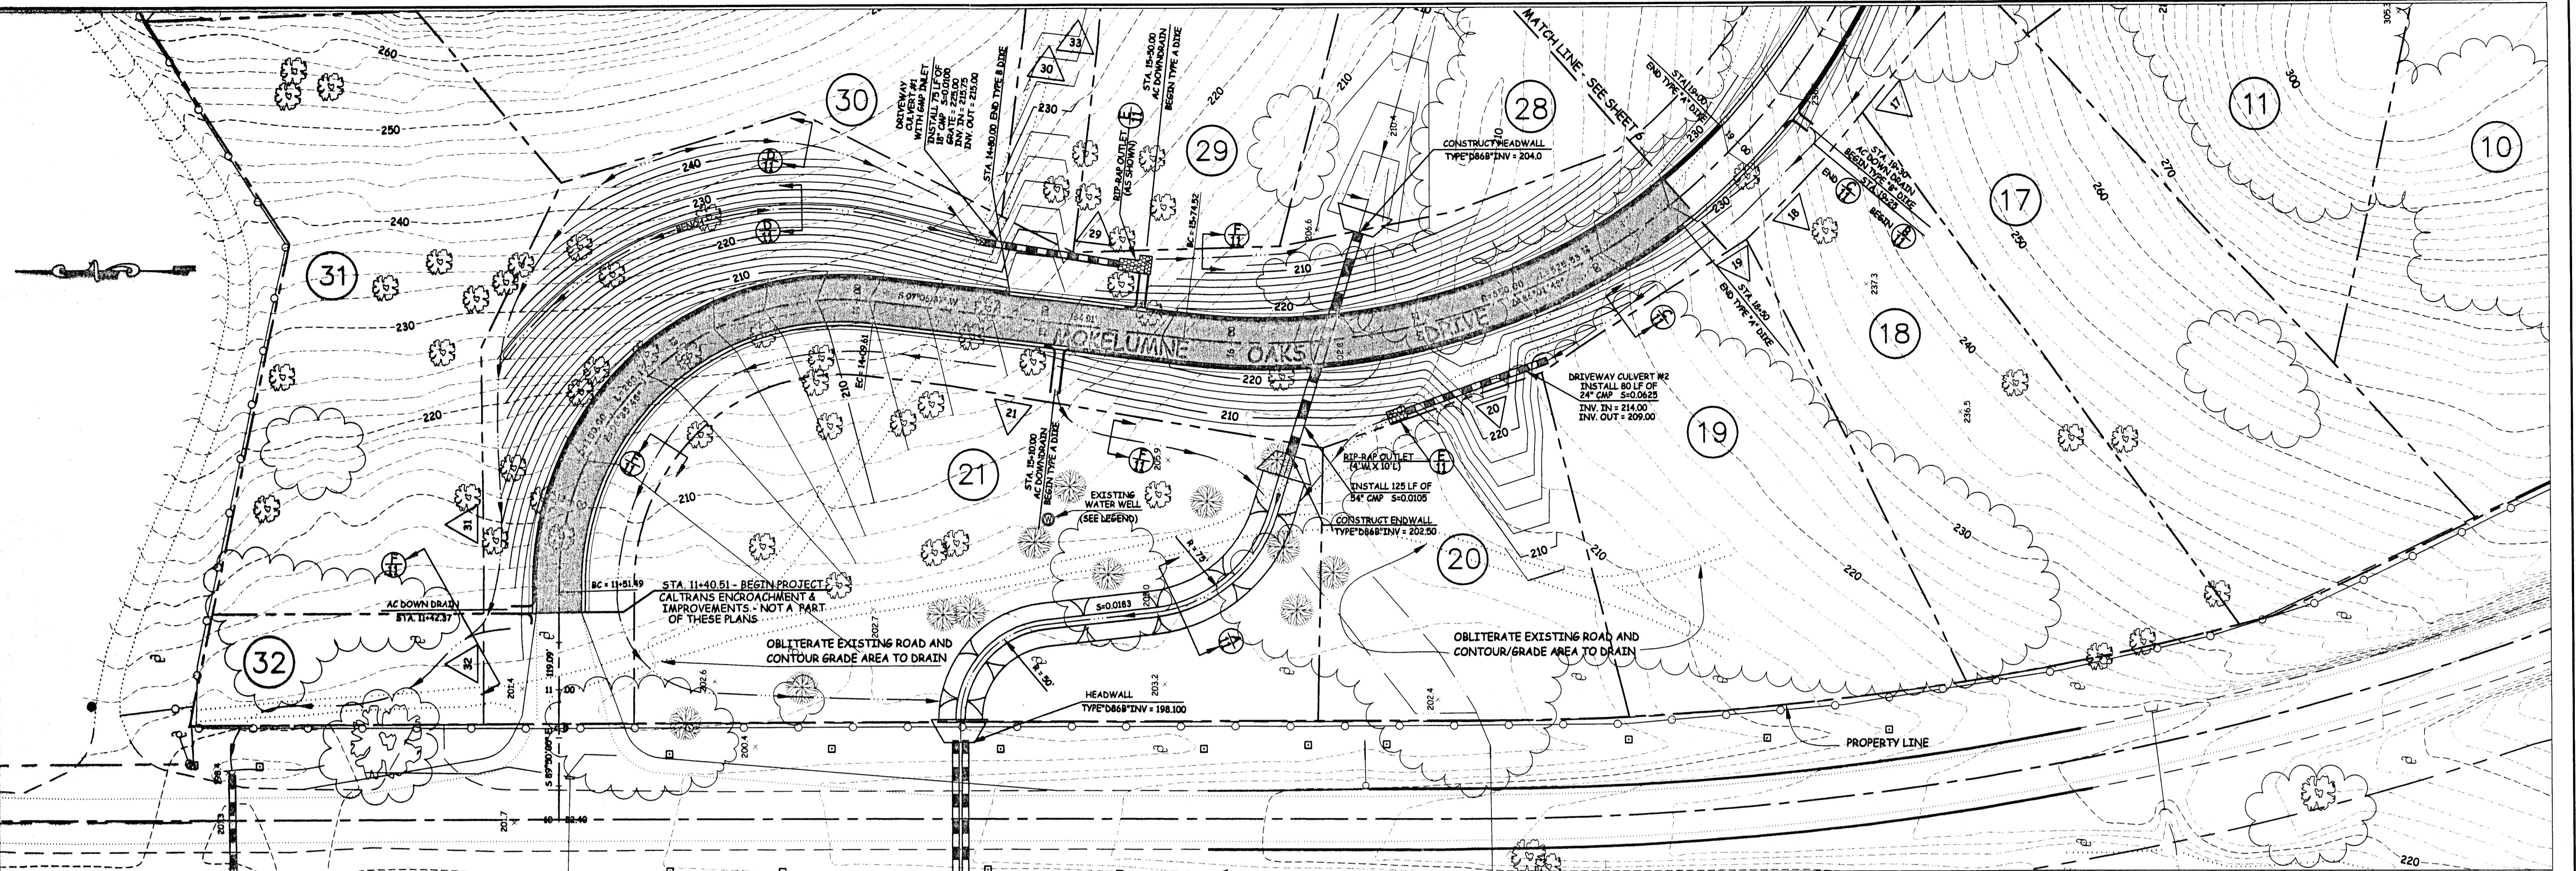
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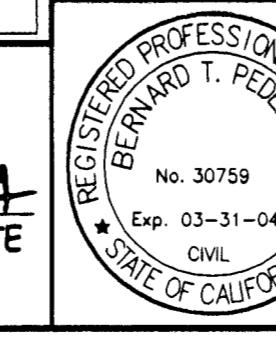


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NO.	REVISION DESCRIPTION	BY:	DATE	APPROVED BY:
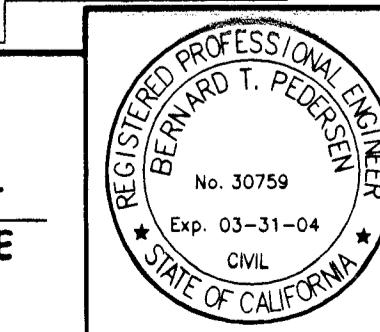
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 BERNARD T. PEDERSEN DATE





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WALLACE PARKWAY

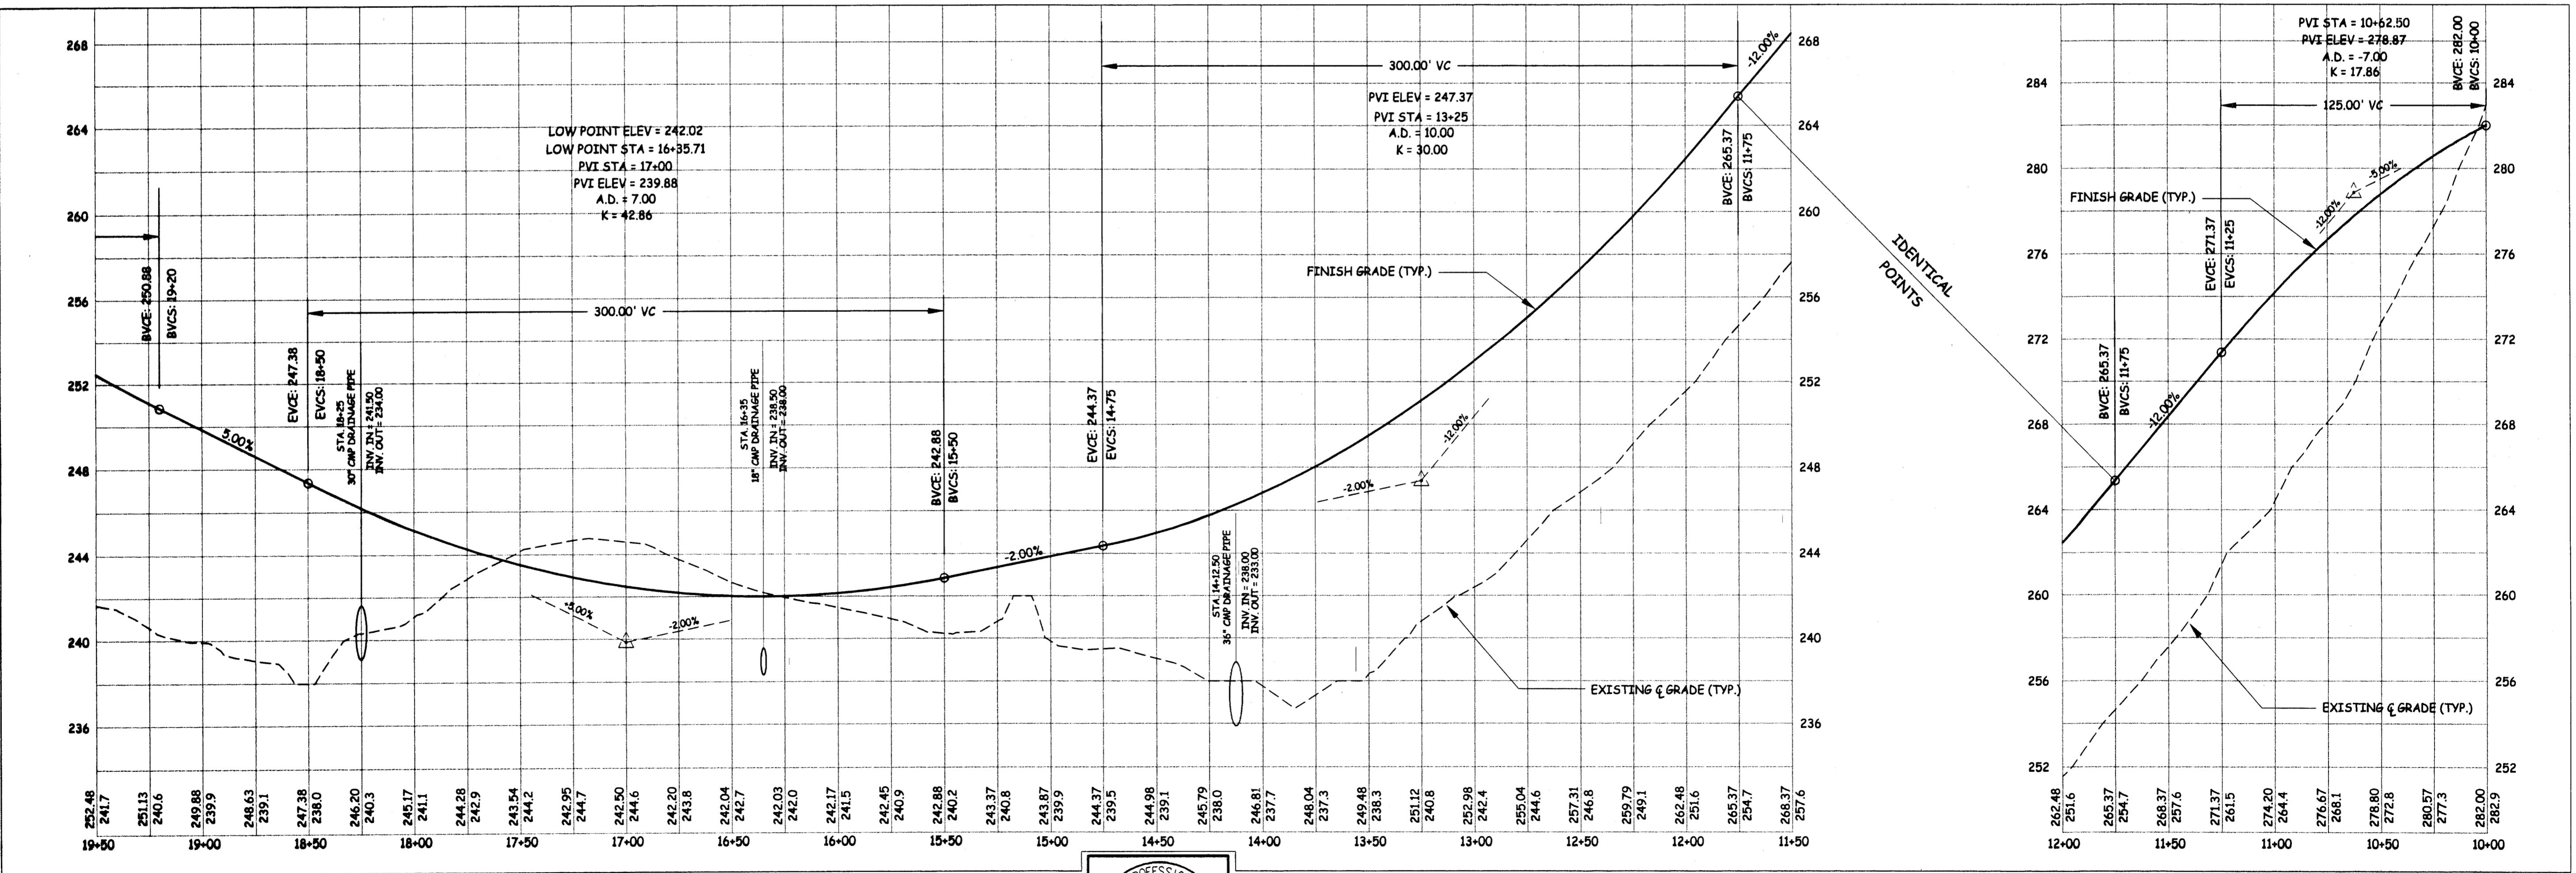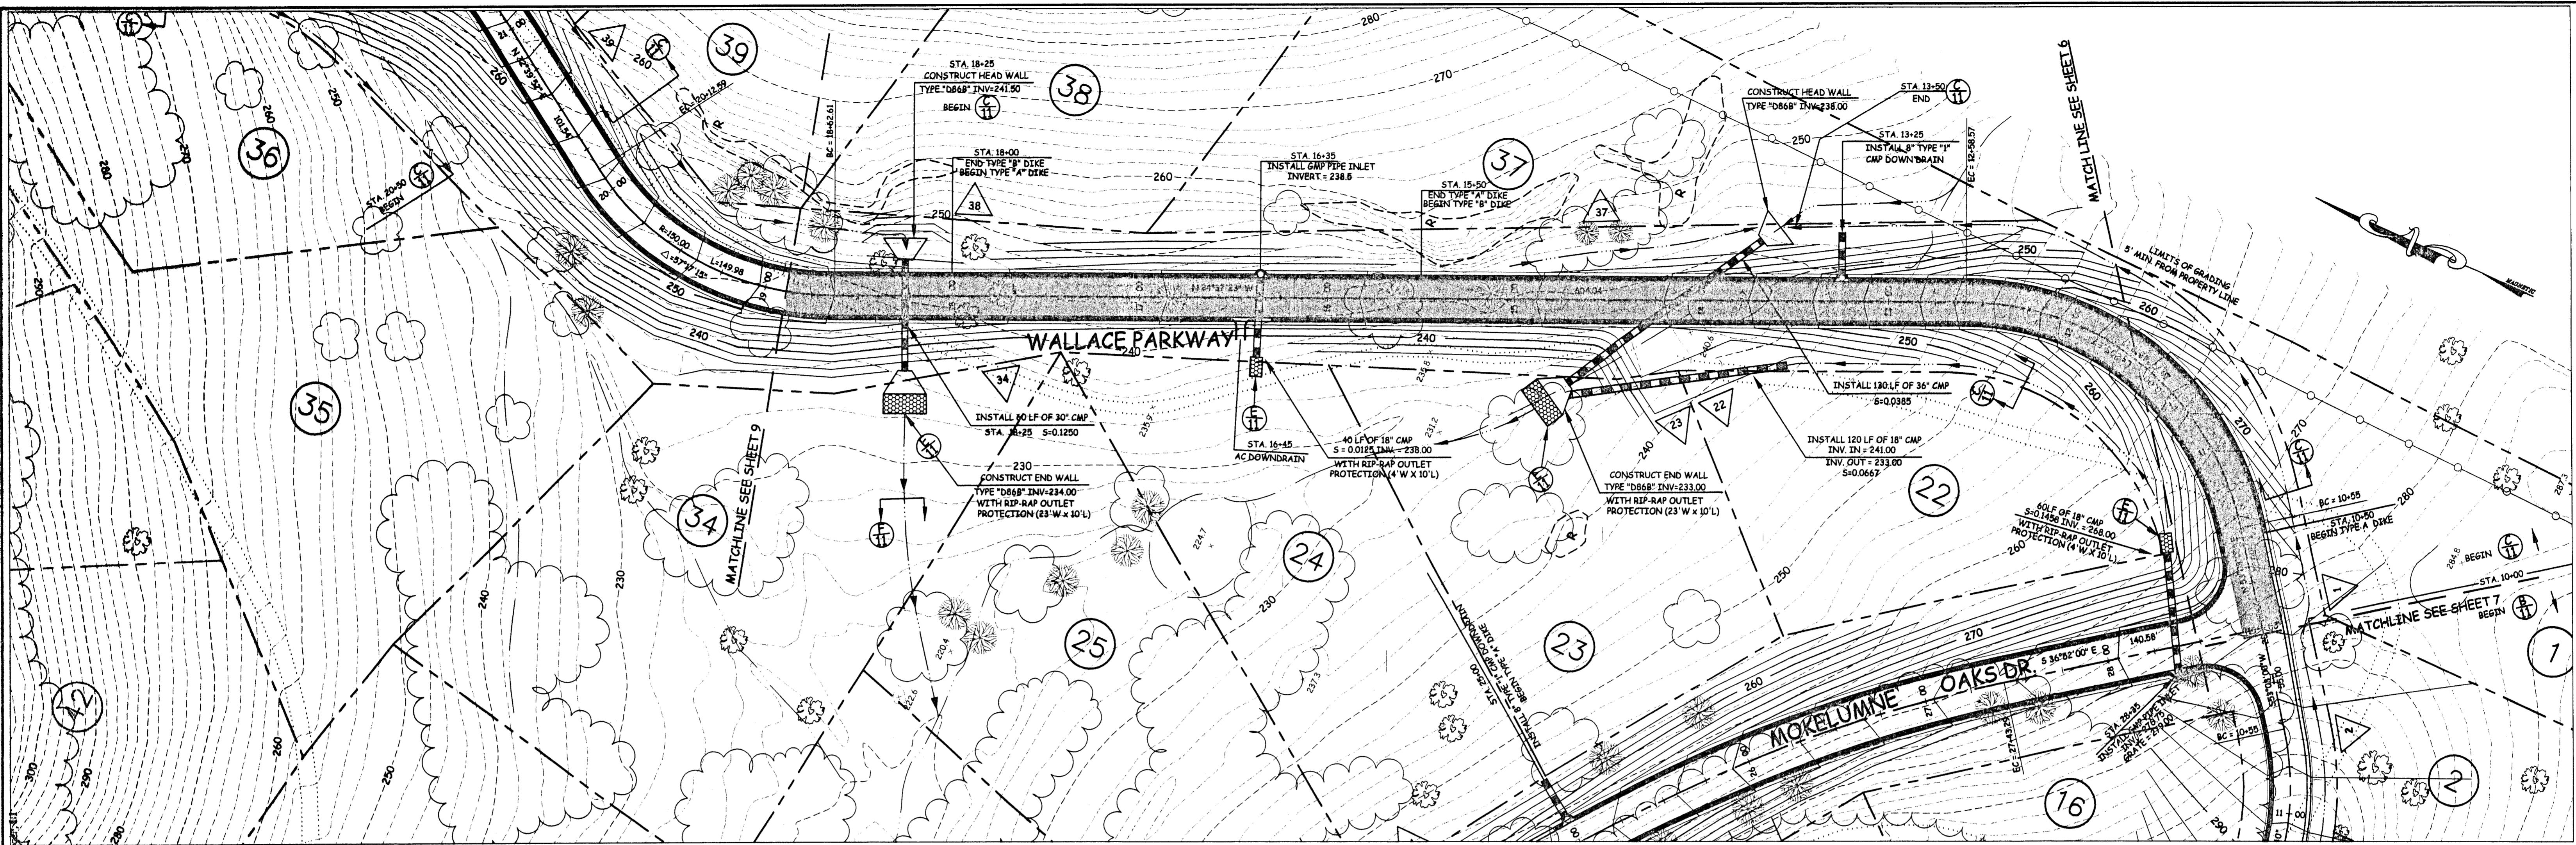MOKELUMNE OAKS SUBDIVISION


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 8 OF 12

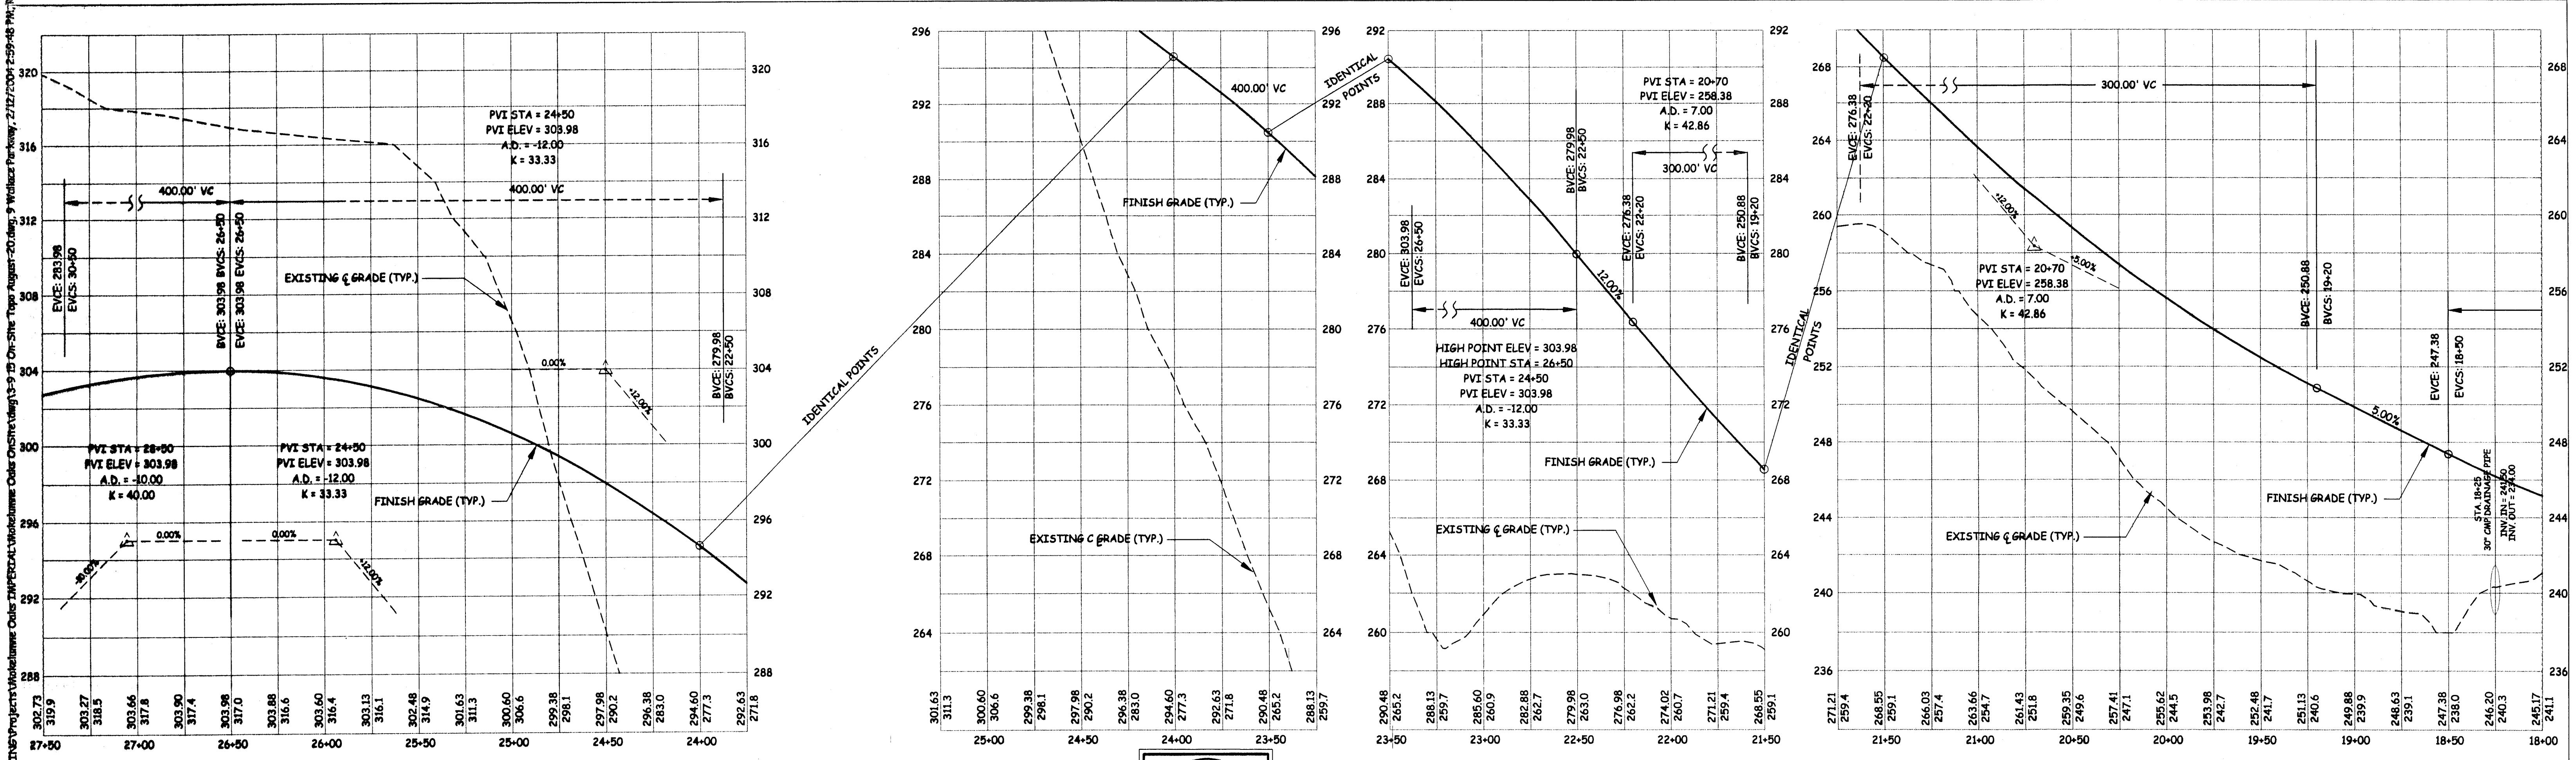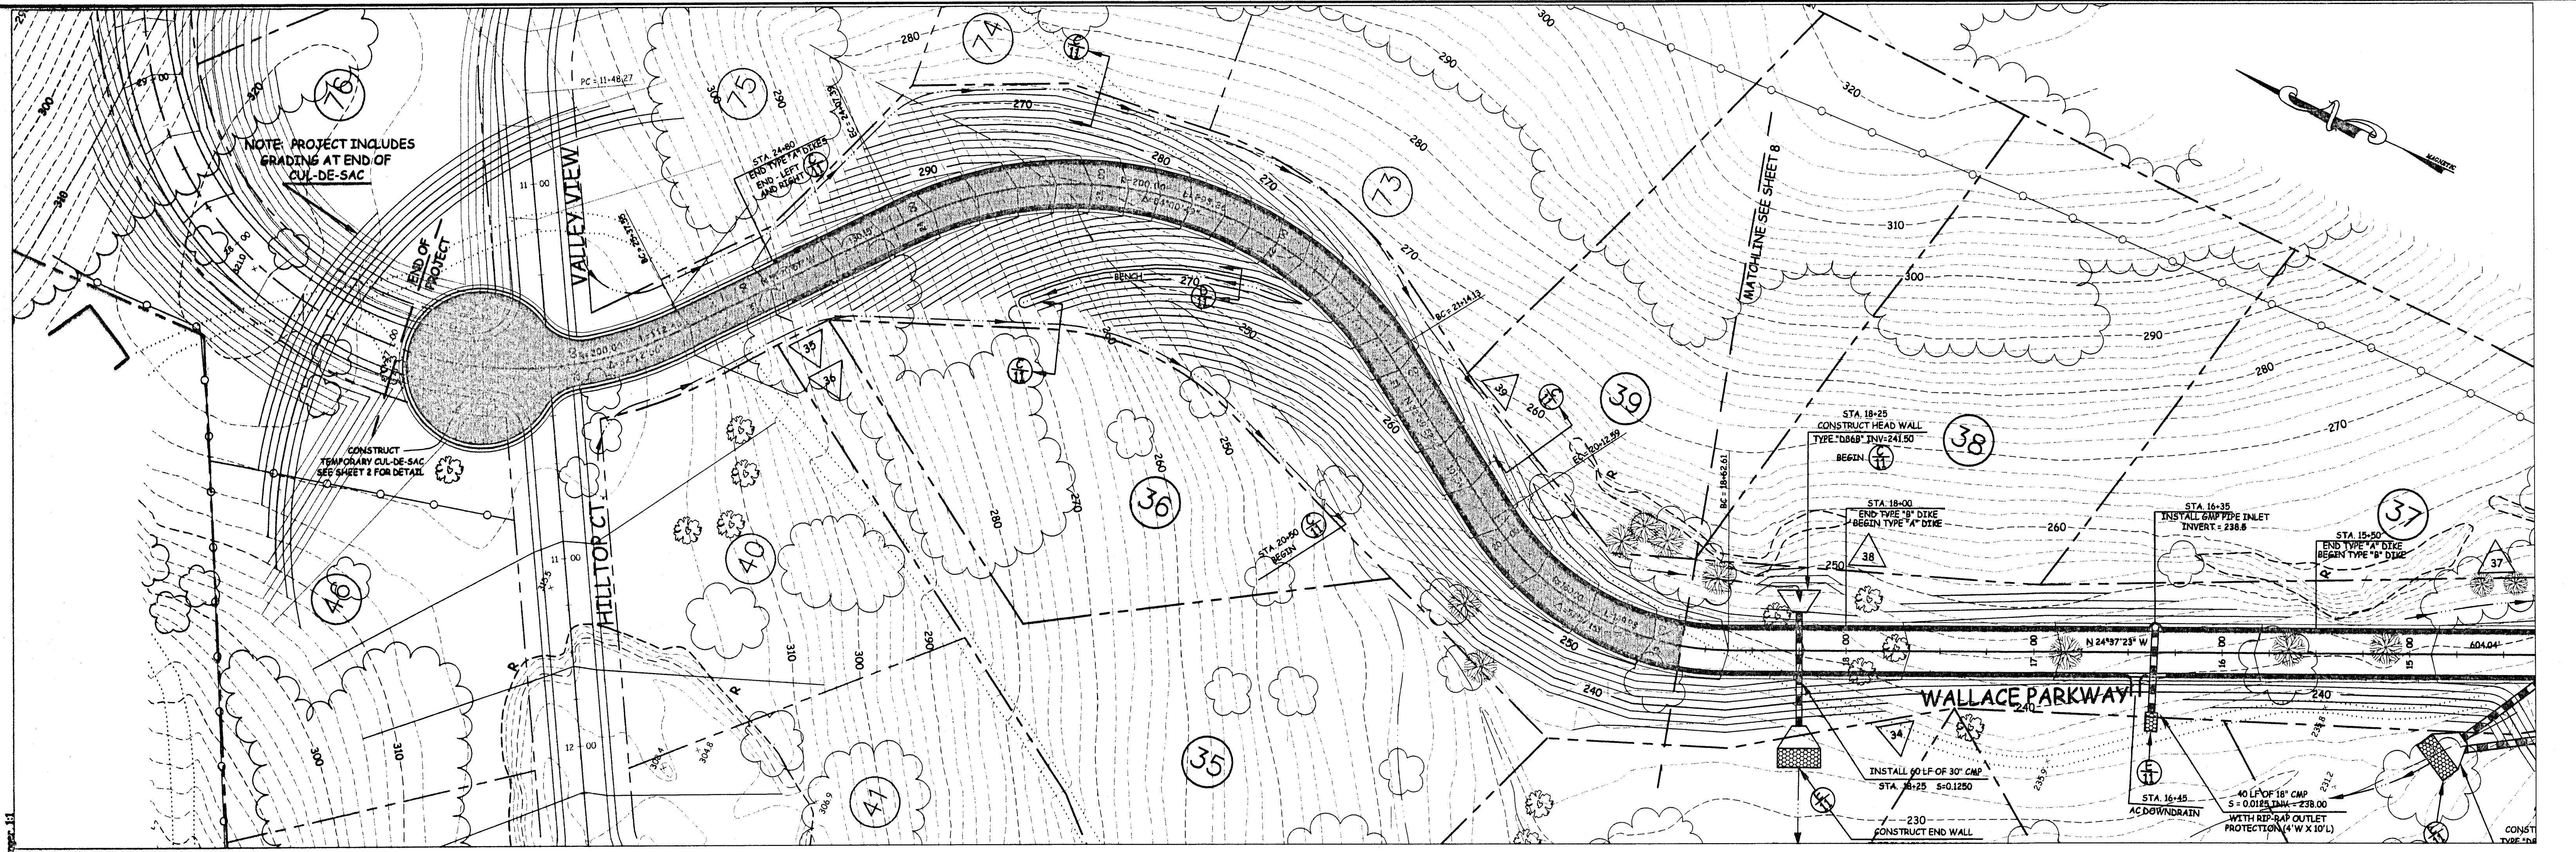

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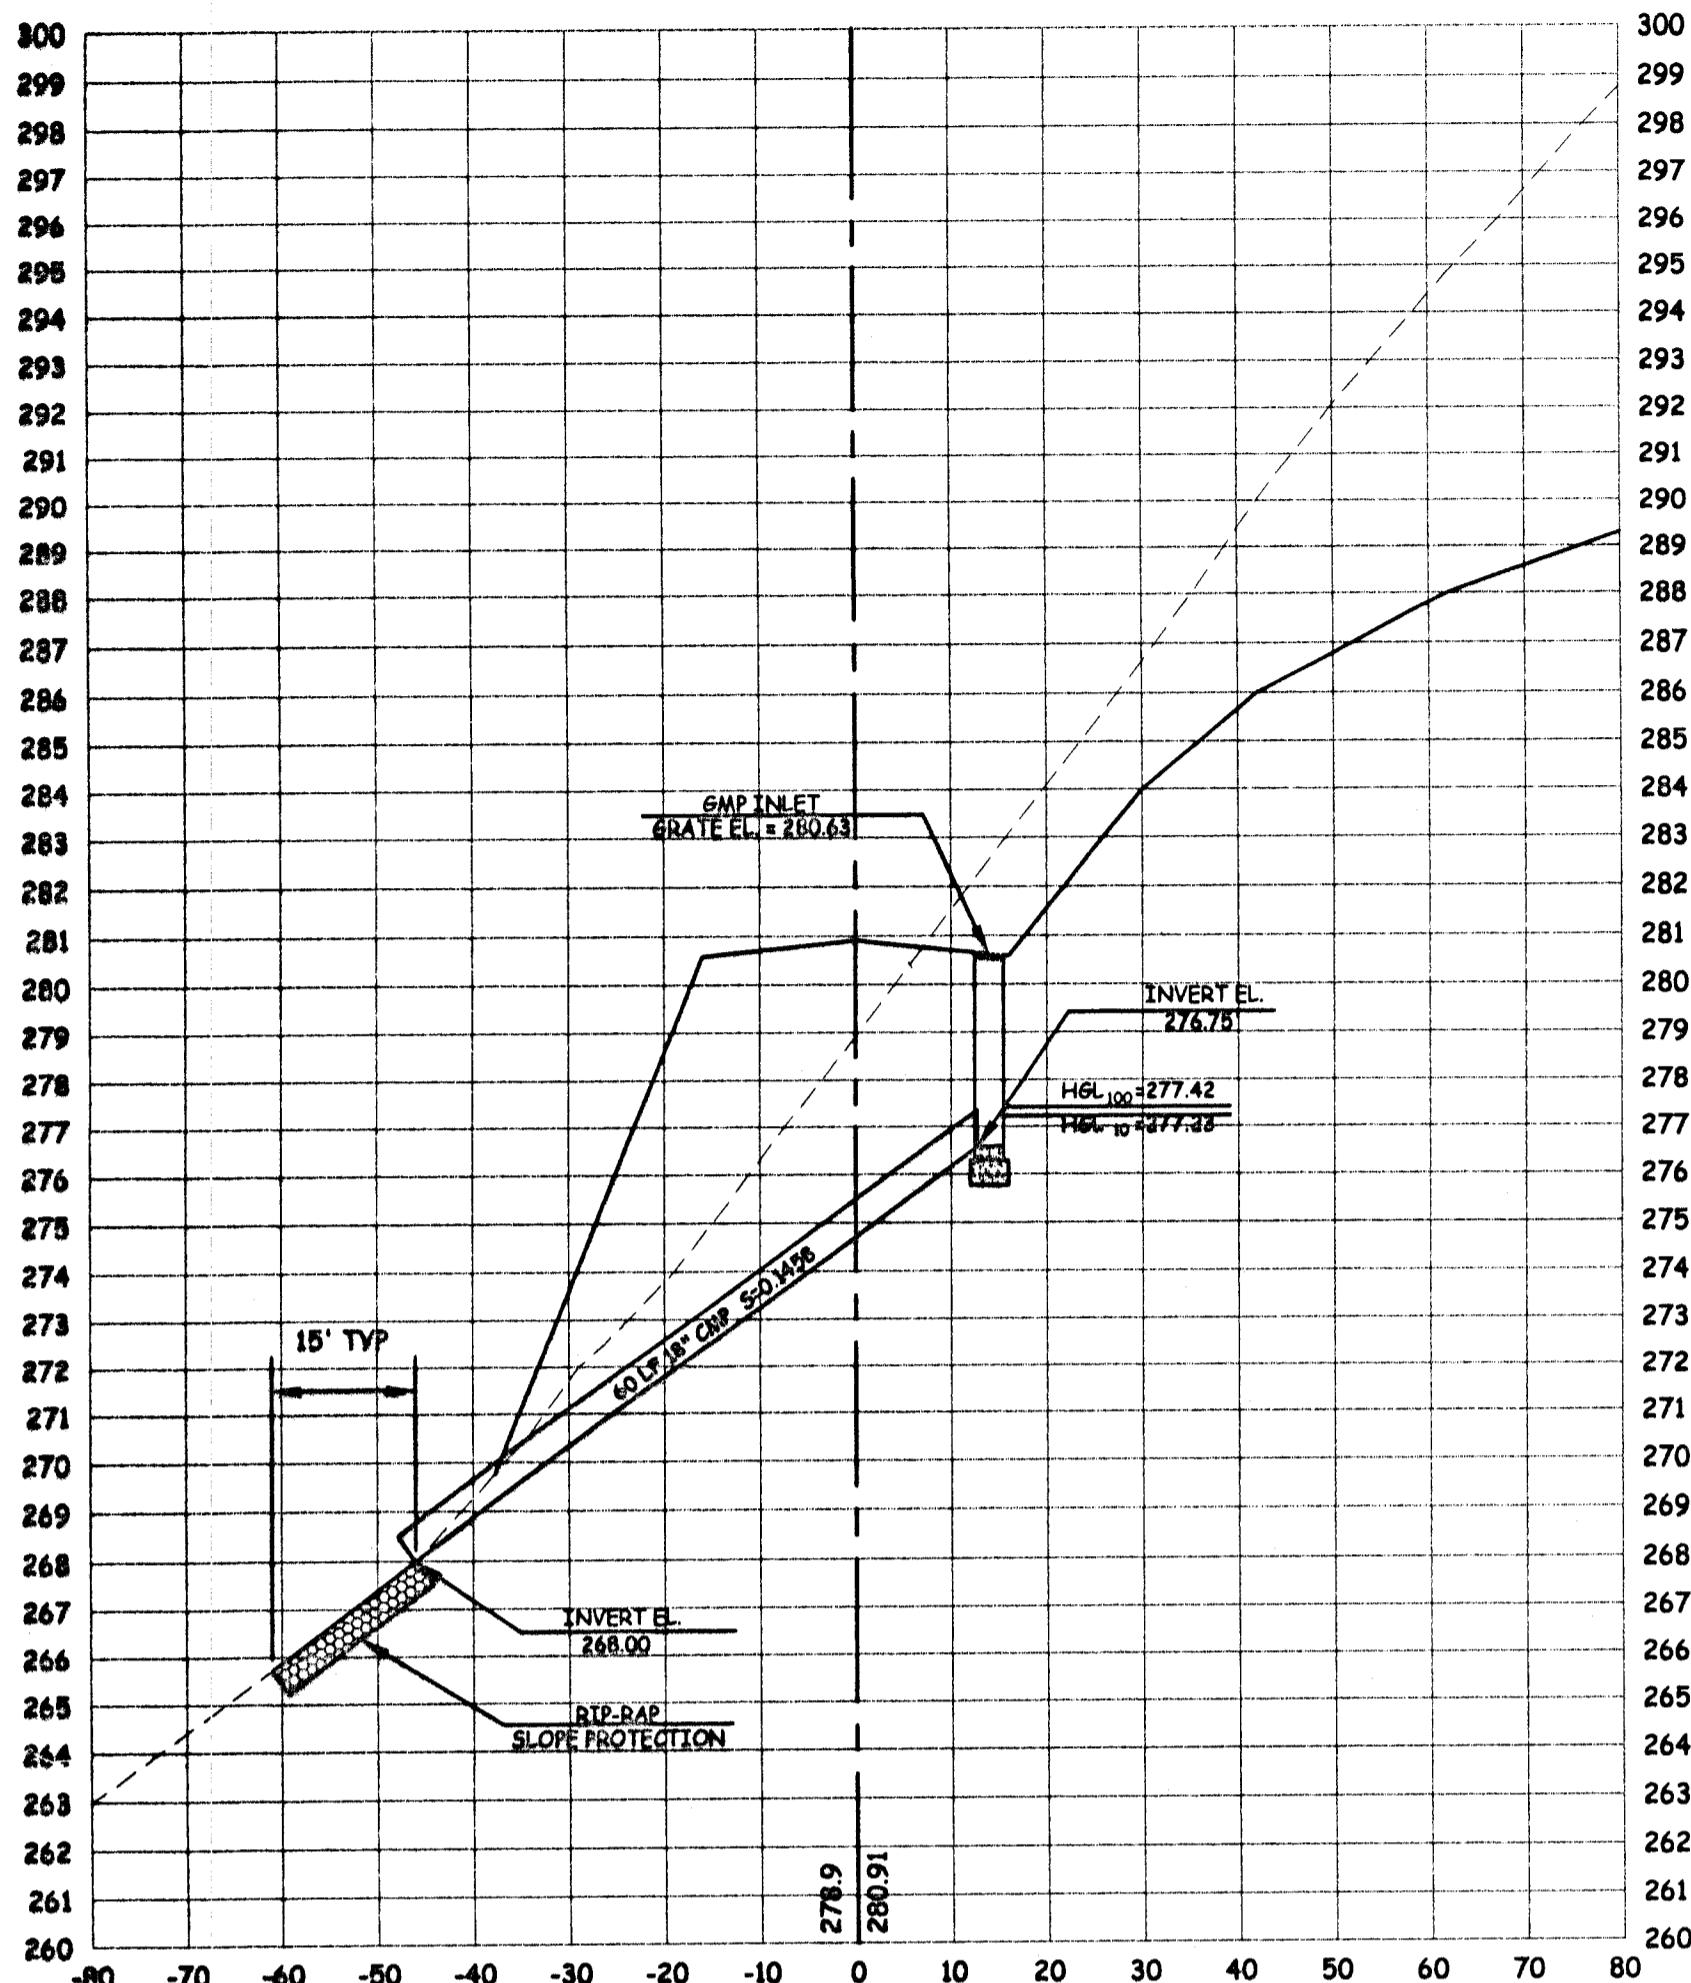
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 MOKELUMNE OAKS SUBDIVISION

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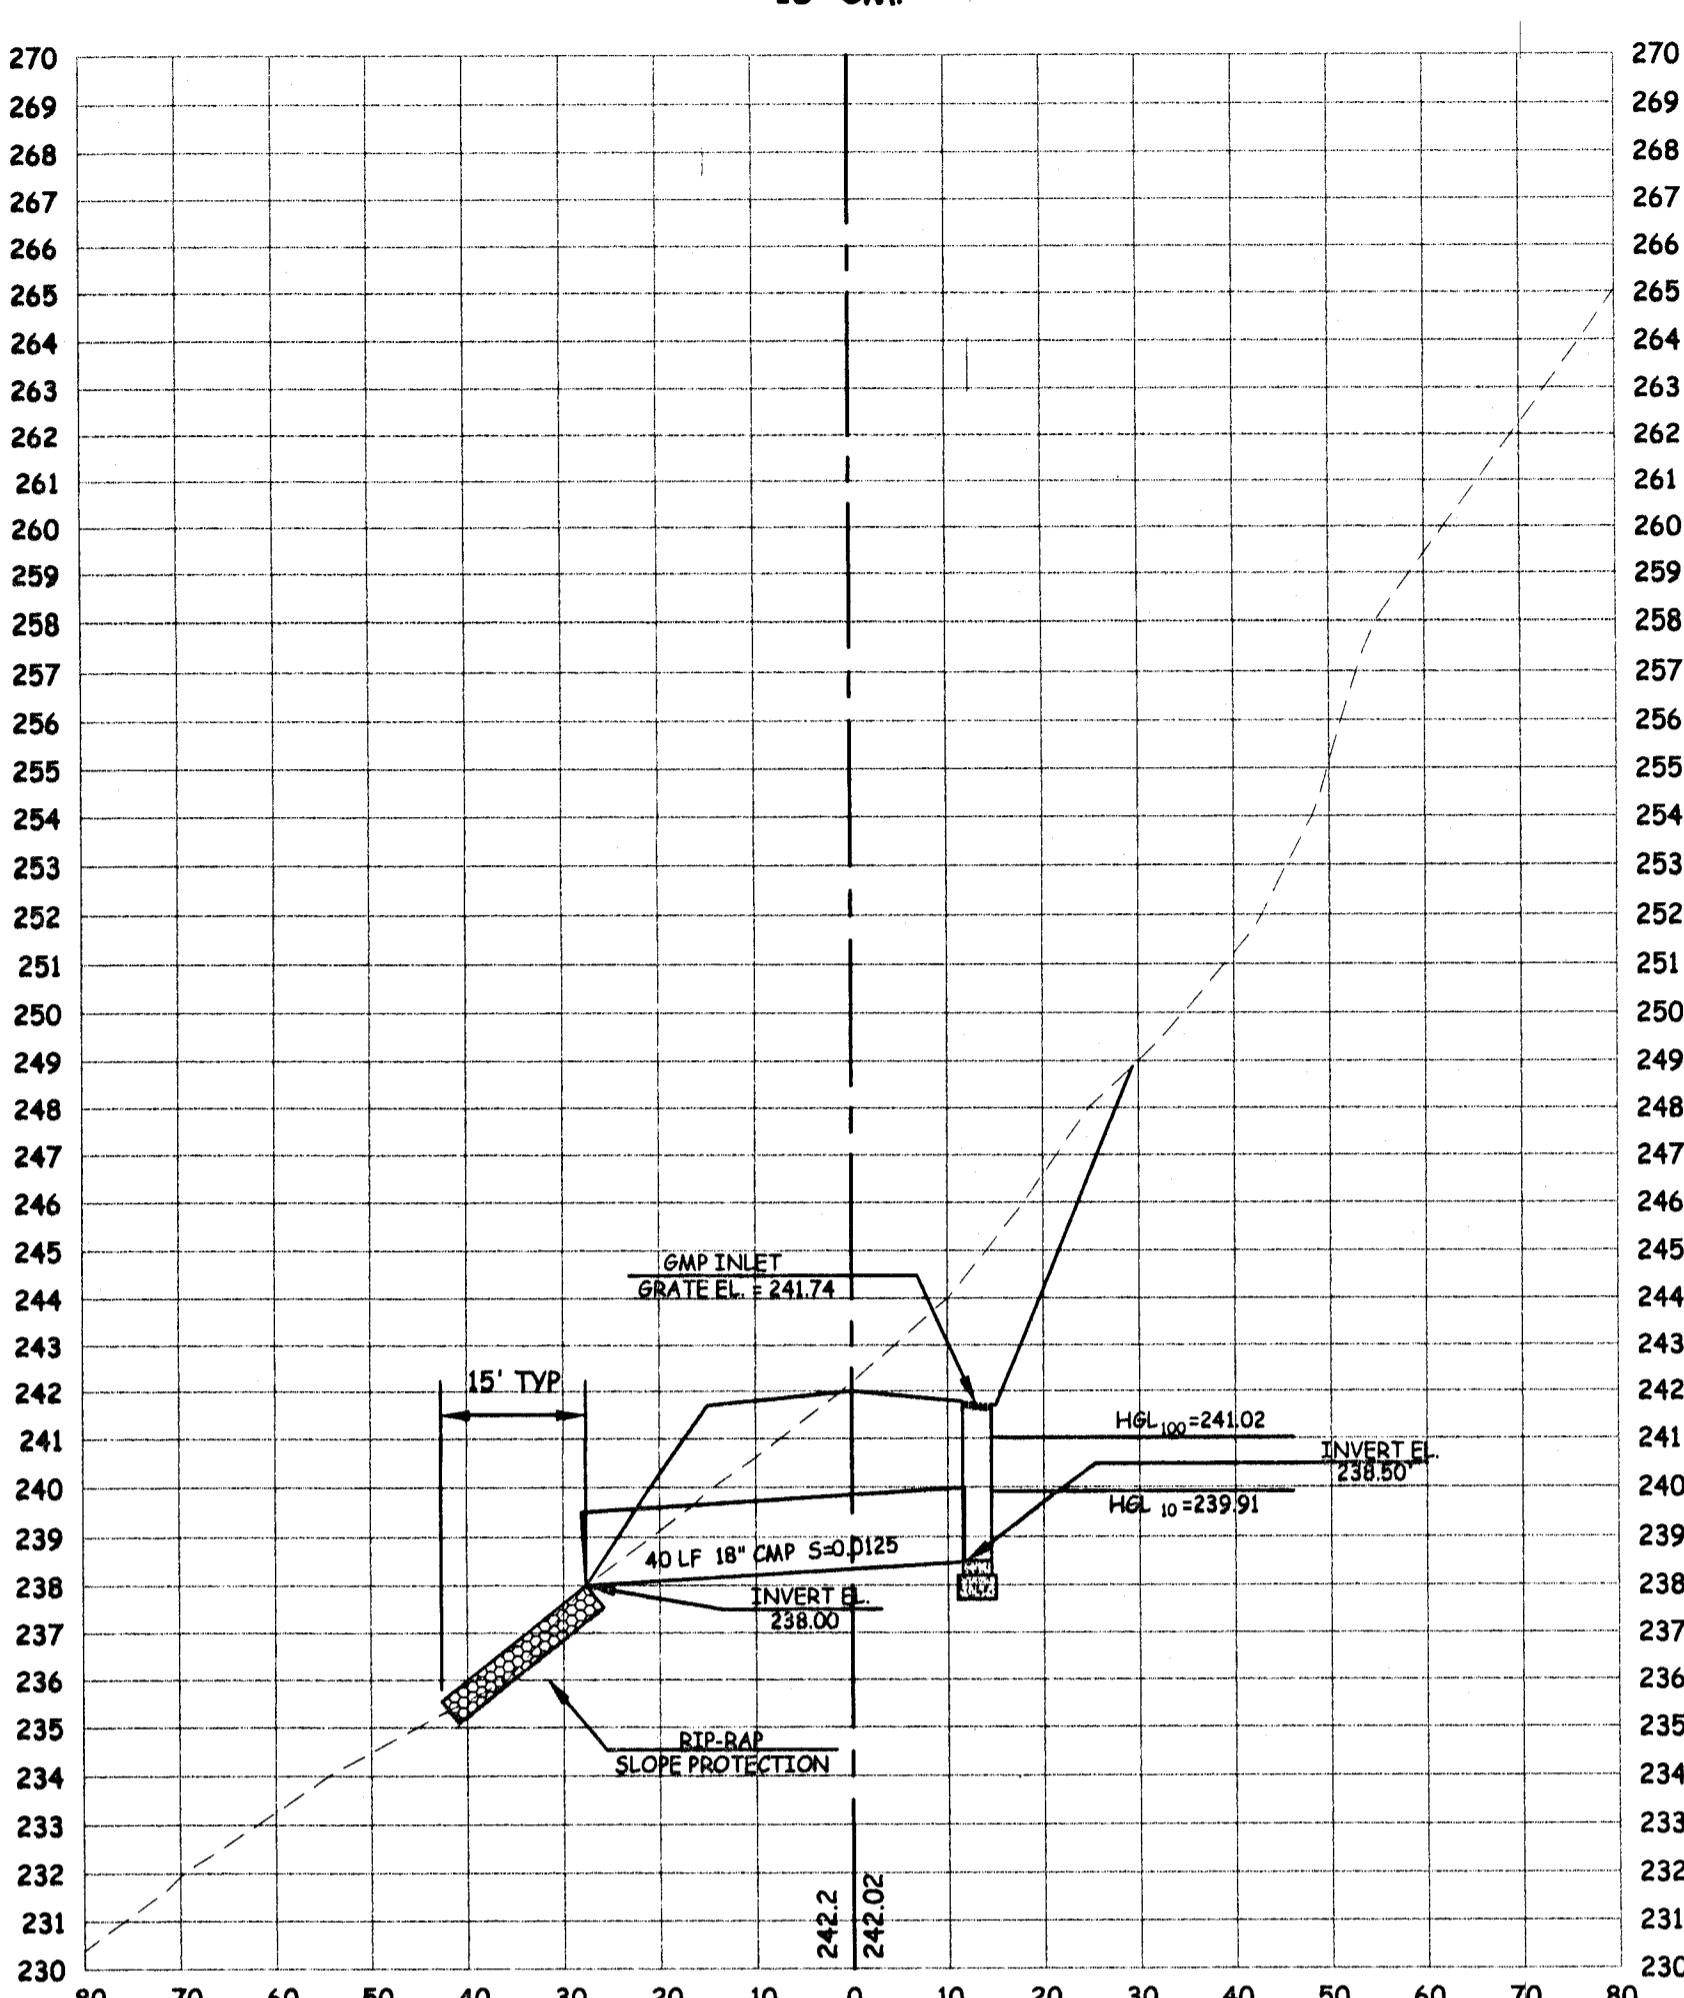
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PROJECT # 0206-22


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18" CMP

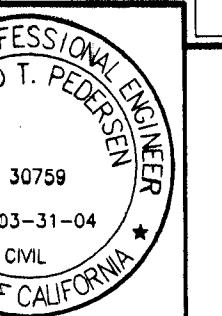


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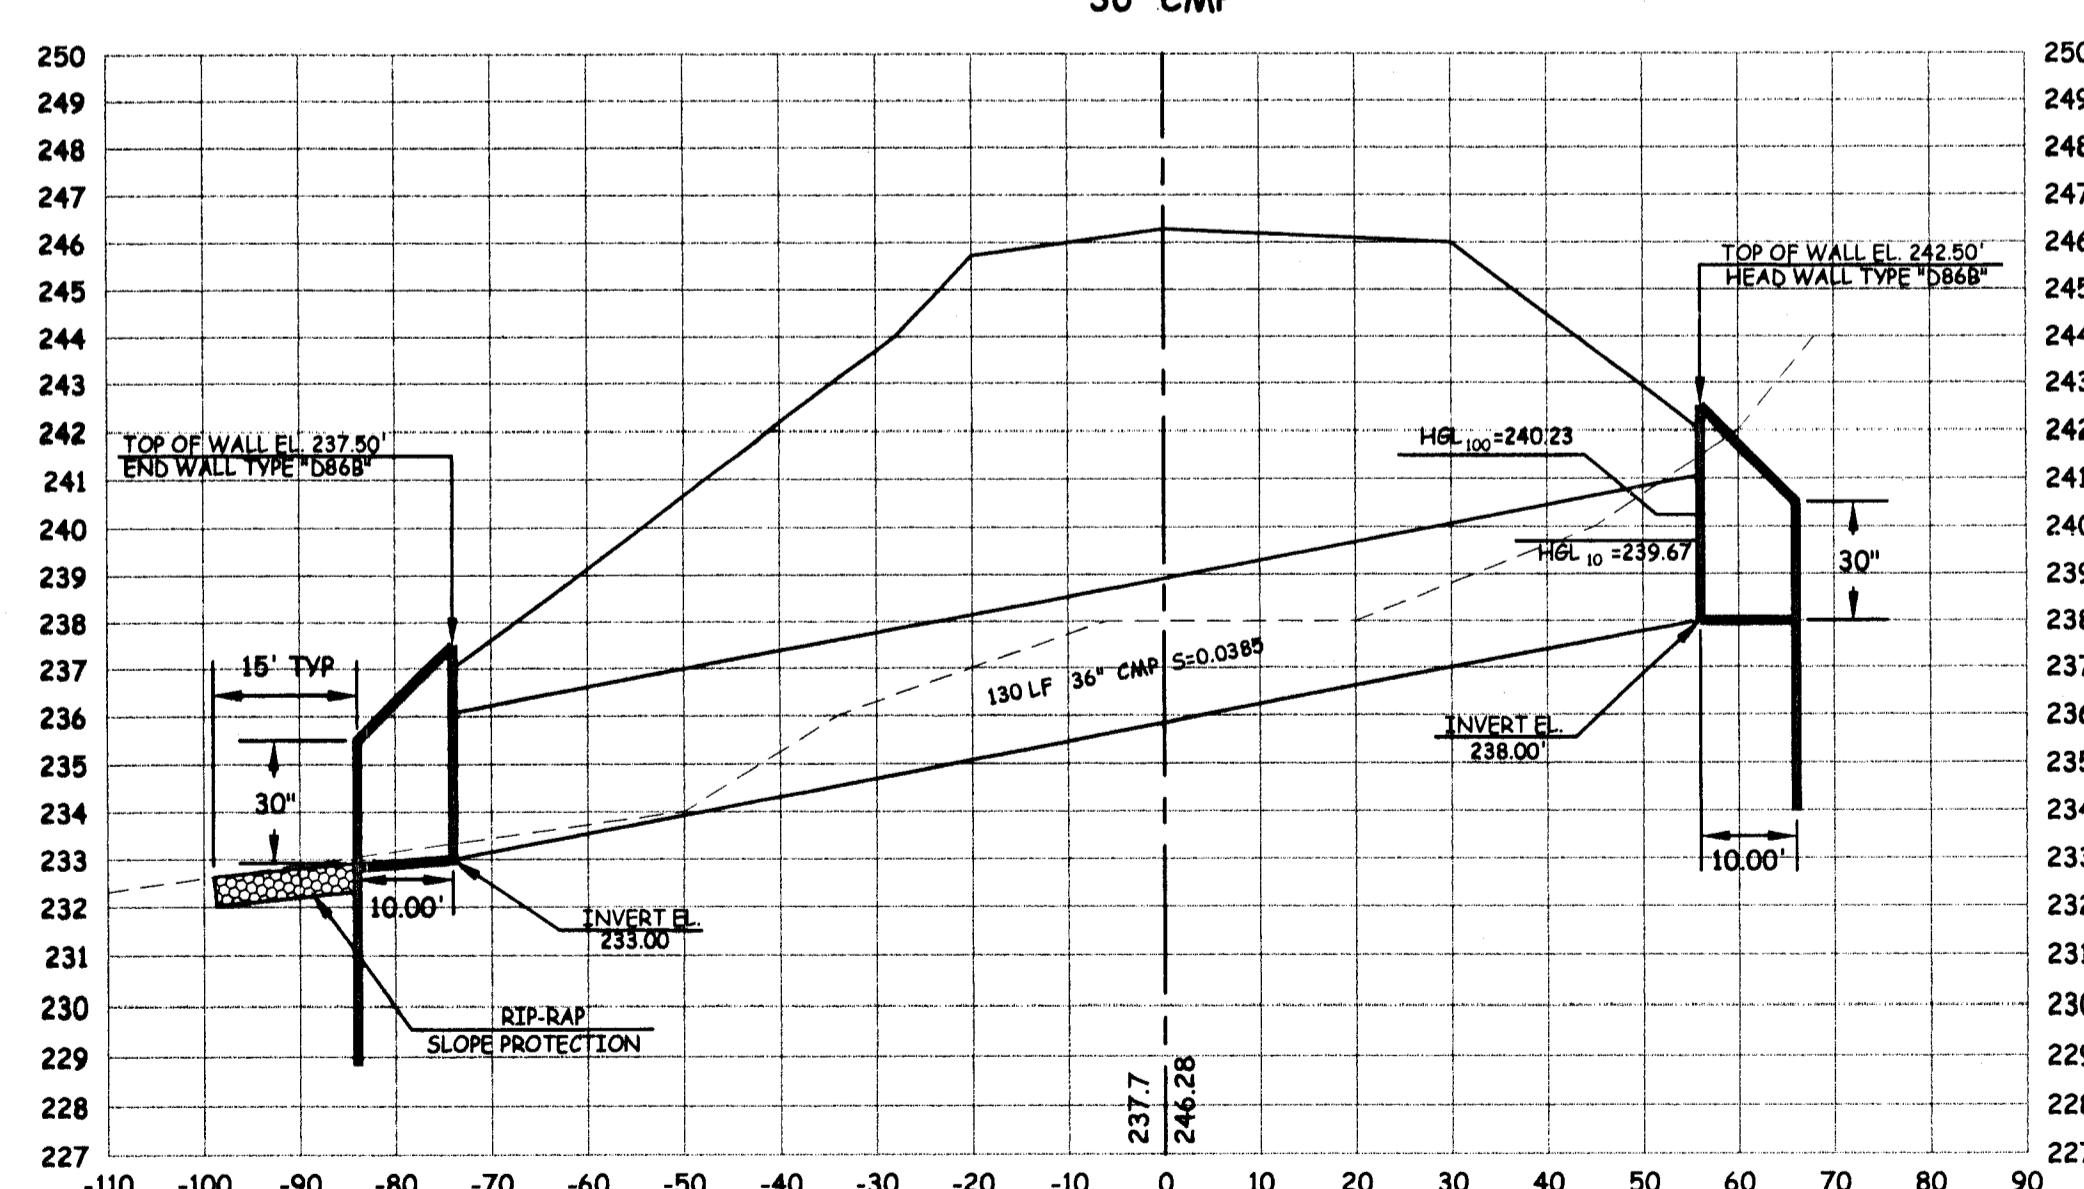
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30" CMP



MOKELUMNE OAKS DRIVE
CL STA. 16+50
54" CMP

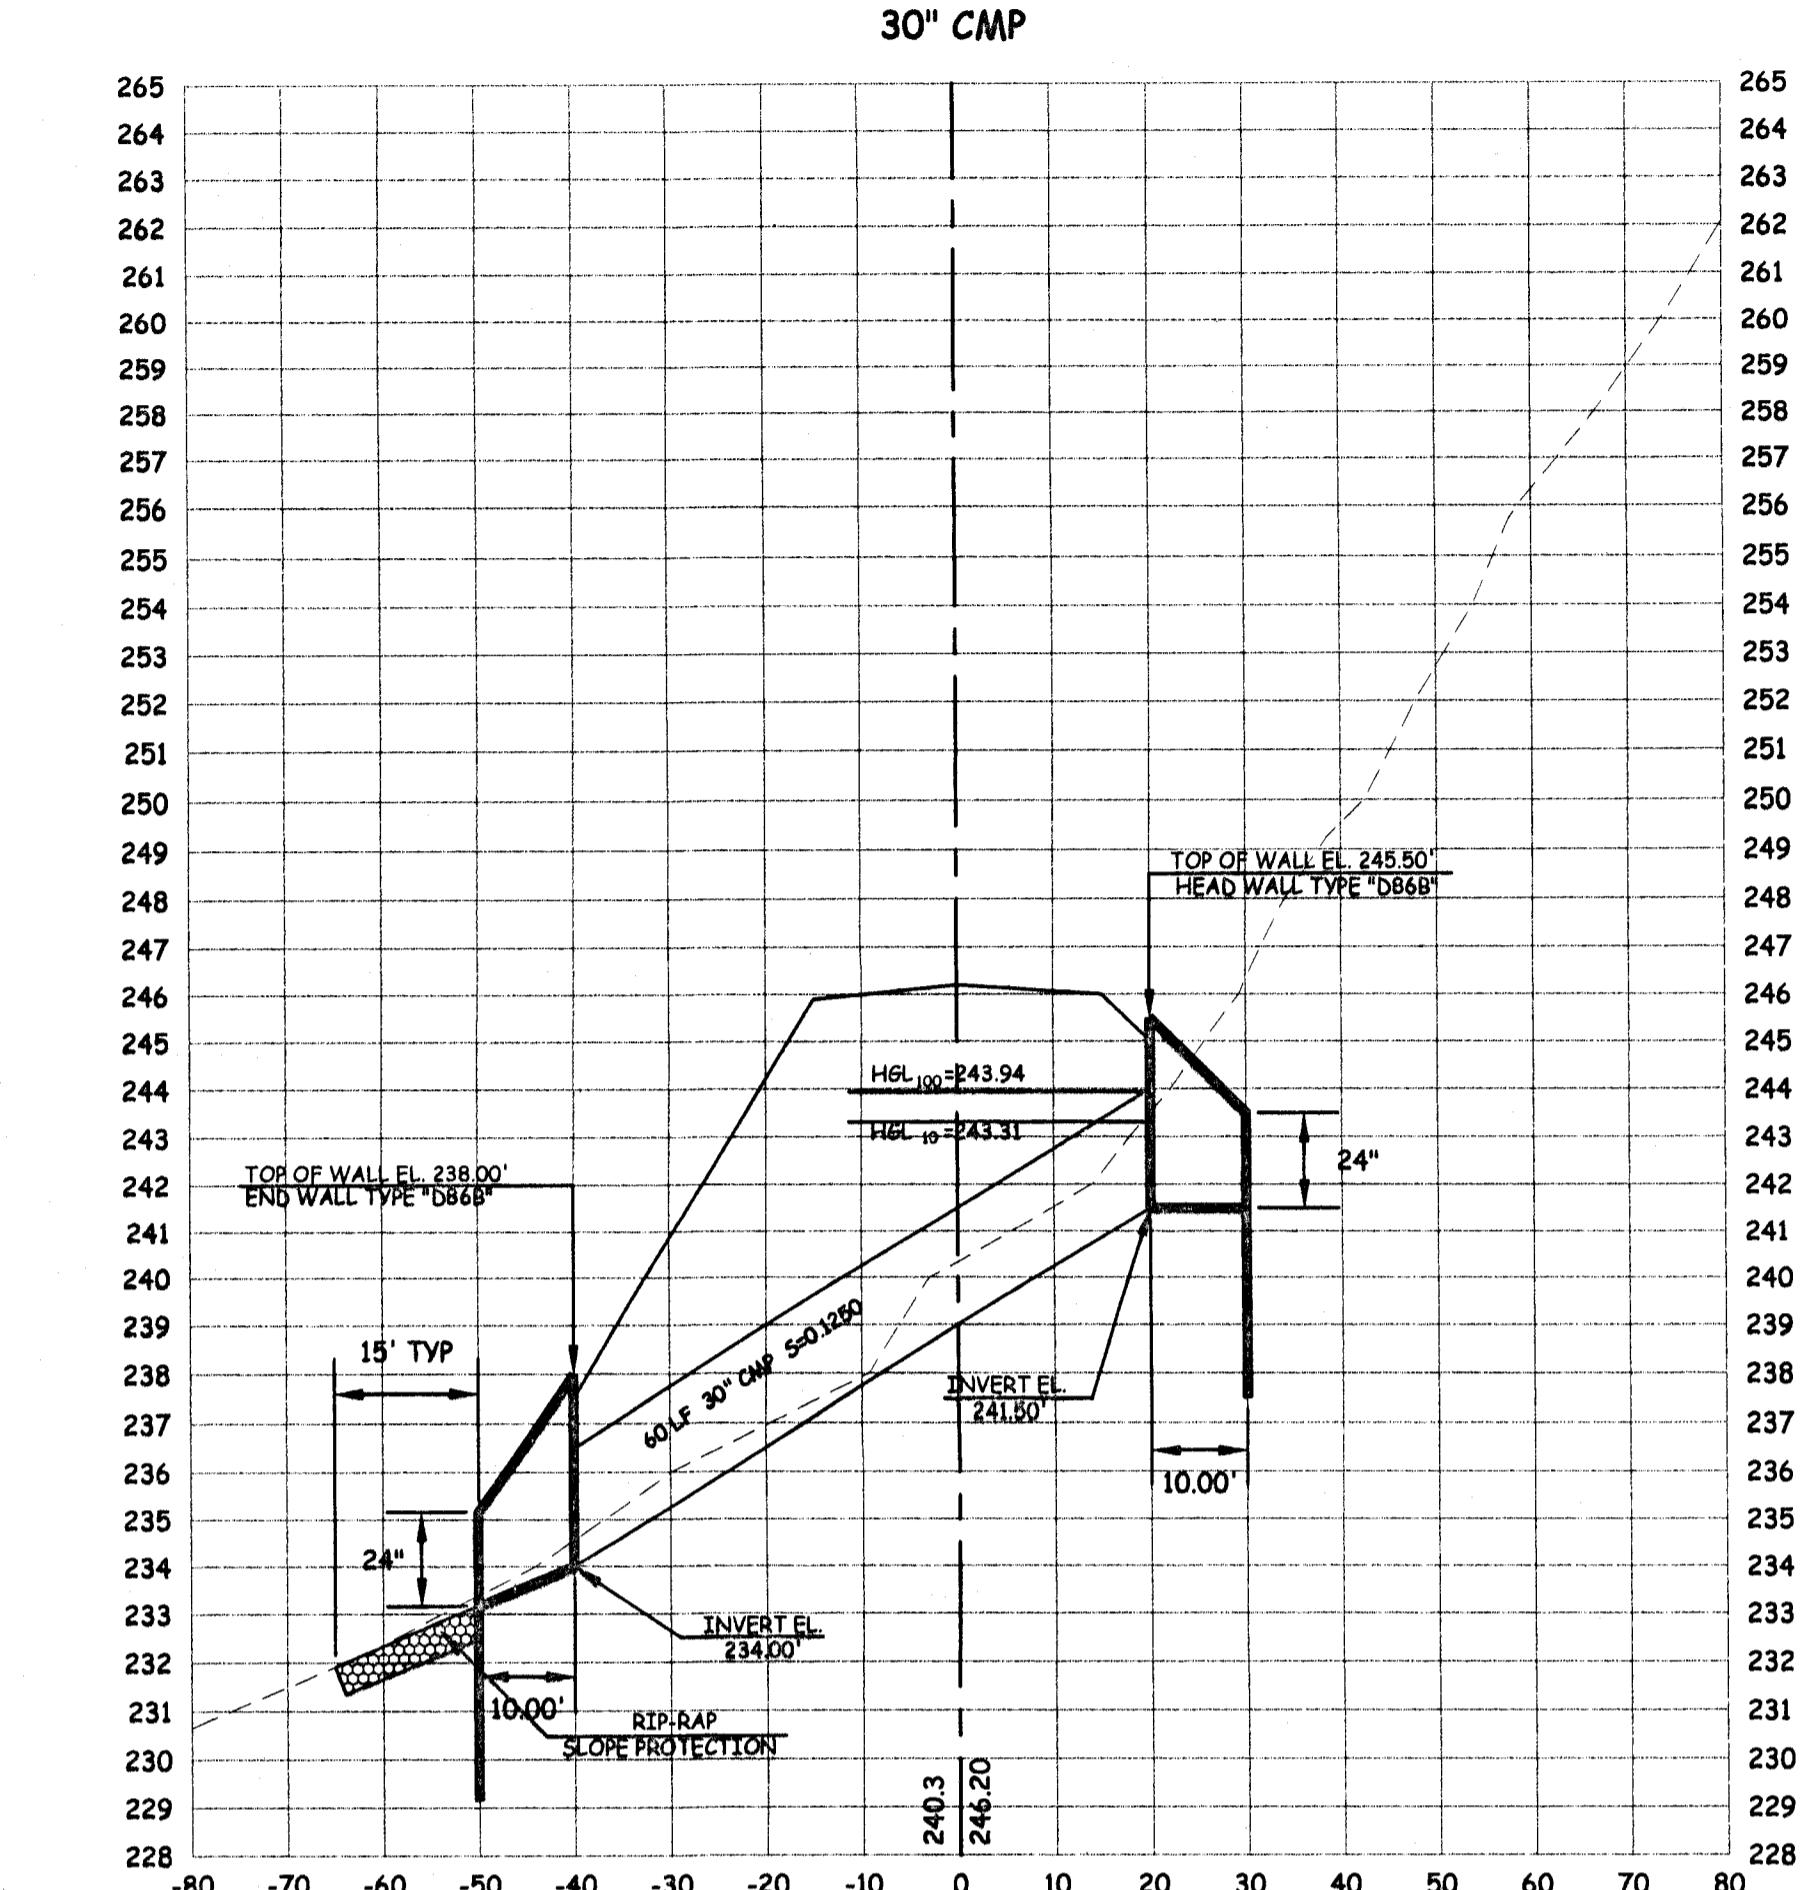


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CL STA. 14+12.50
36" CMP

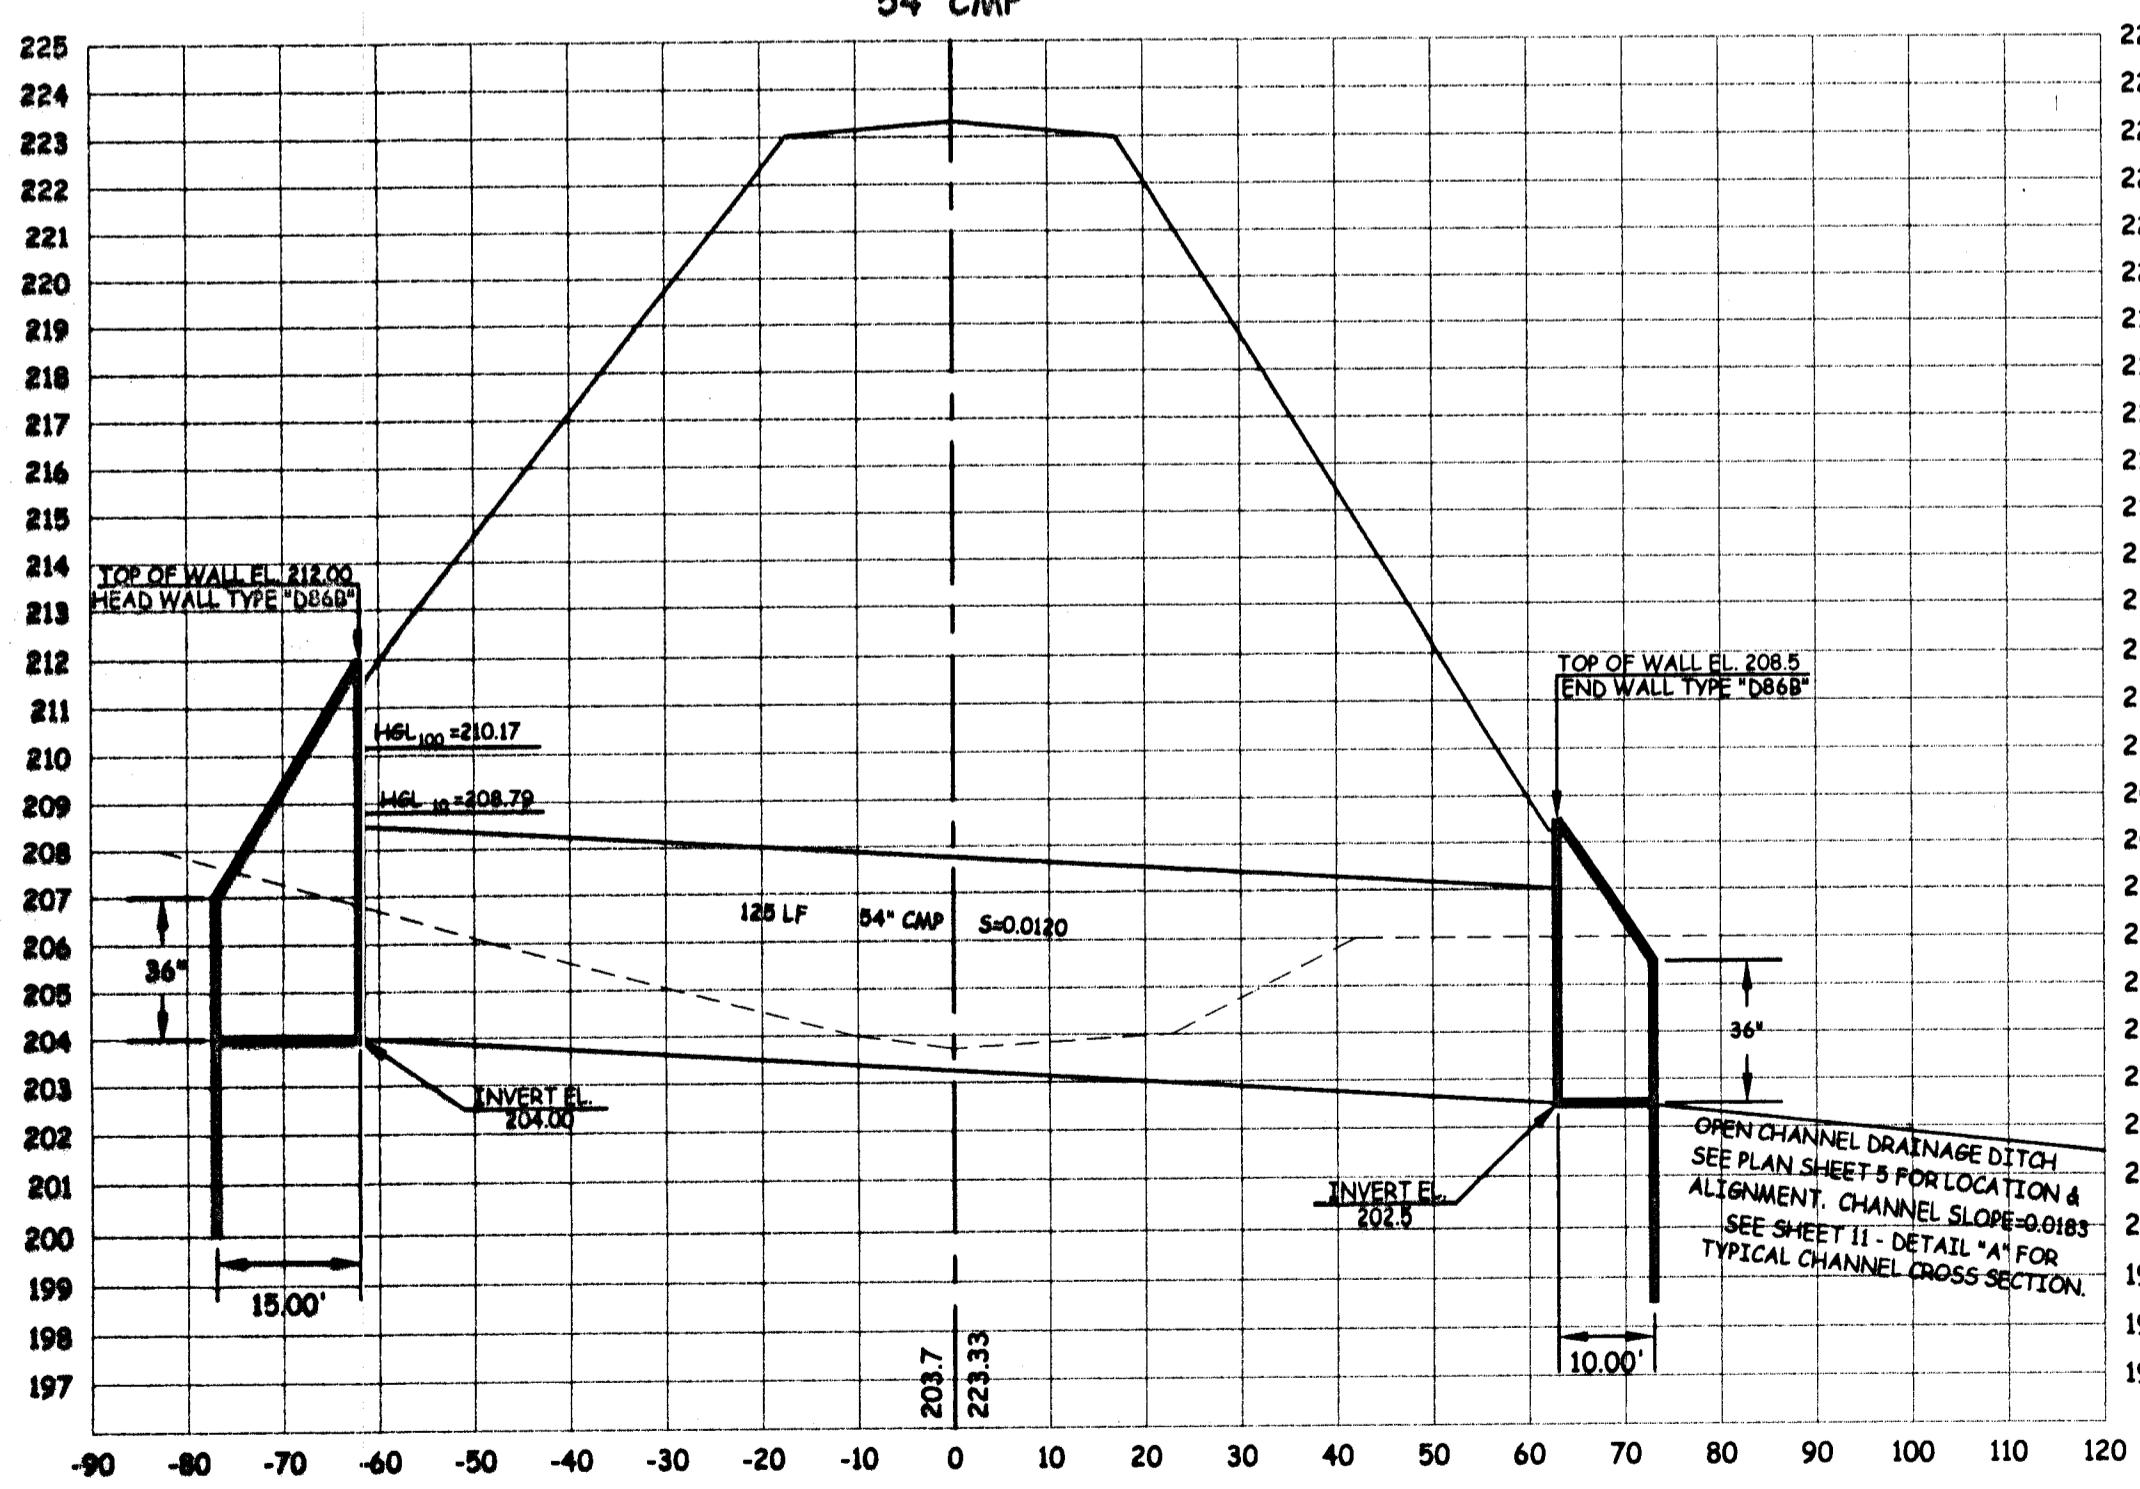

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Bernard T. Pedersen 2/13/04
BERNARD T. PEDERSEN












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DRAINAGE PROFILES

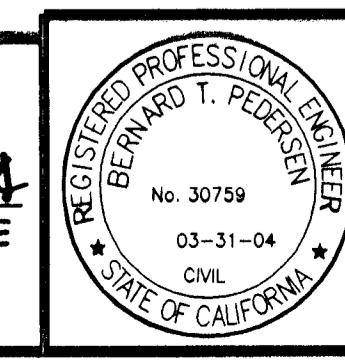MOKELOMNE OAKS SUBDIVISION

PROJECT # 0206-22
SHEET
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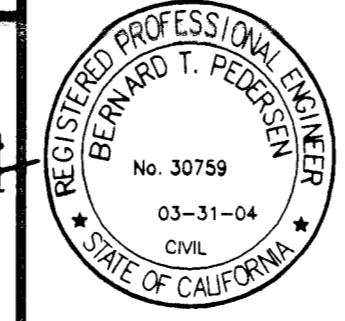


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DRAWN: JR
DESIGNED: TP
CHECKED: TP
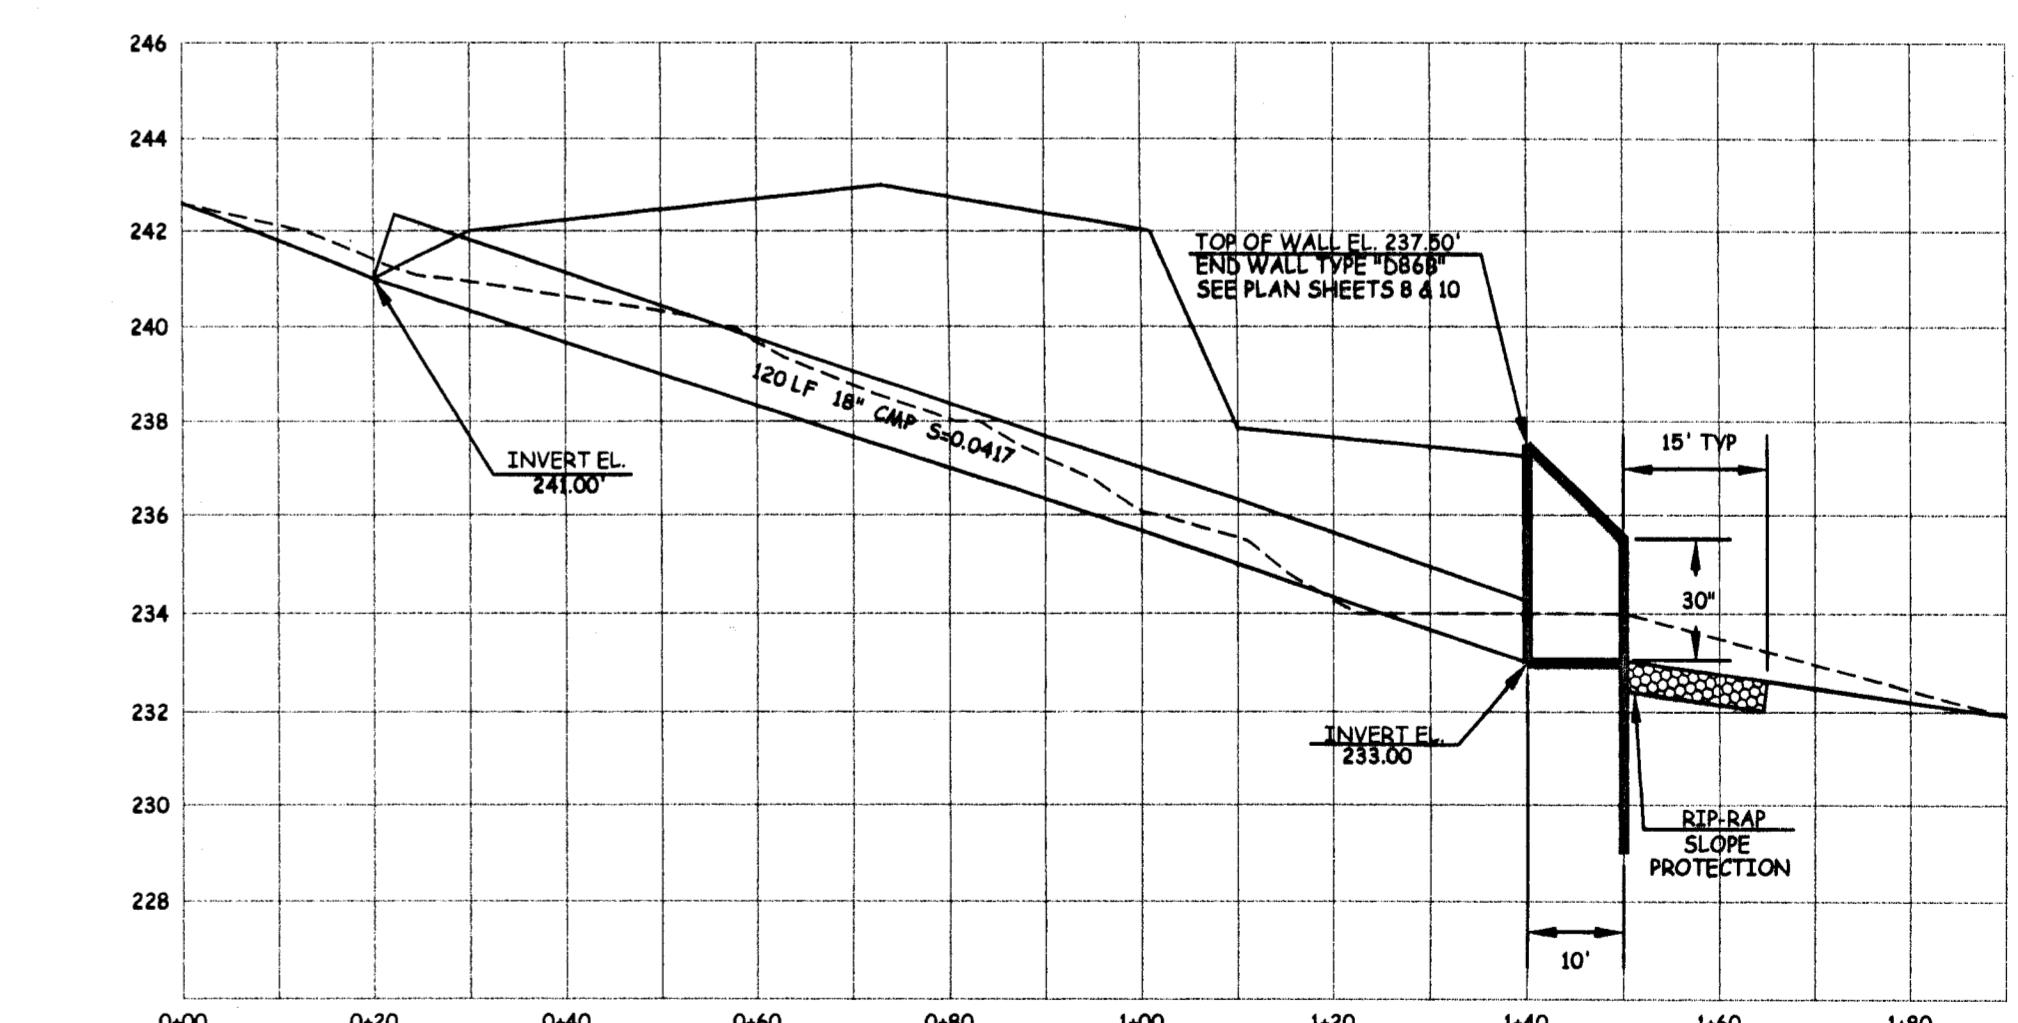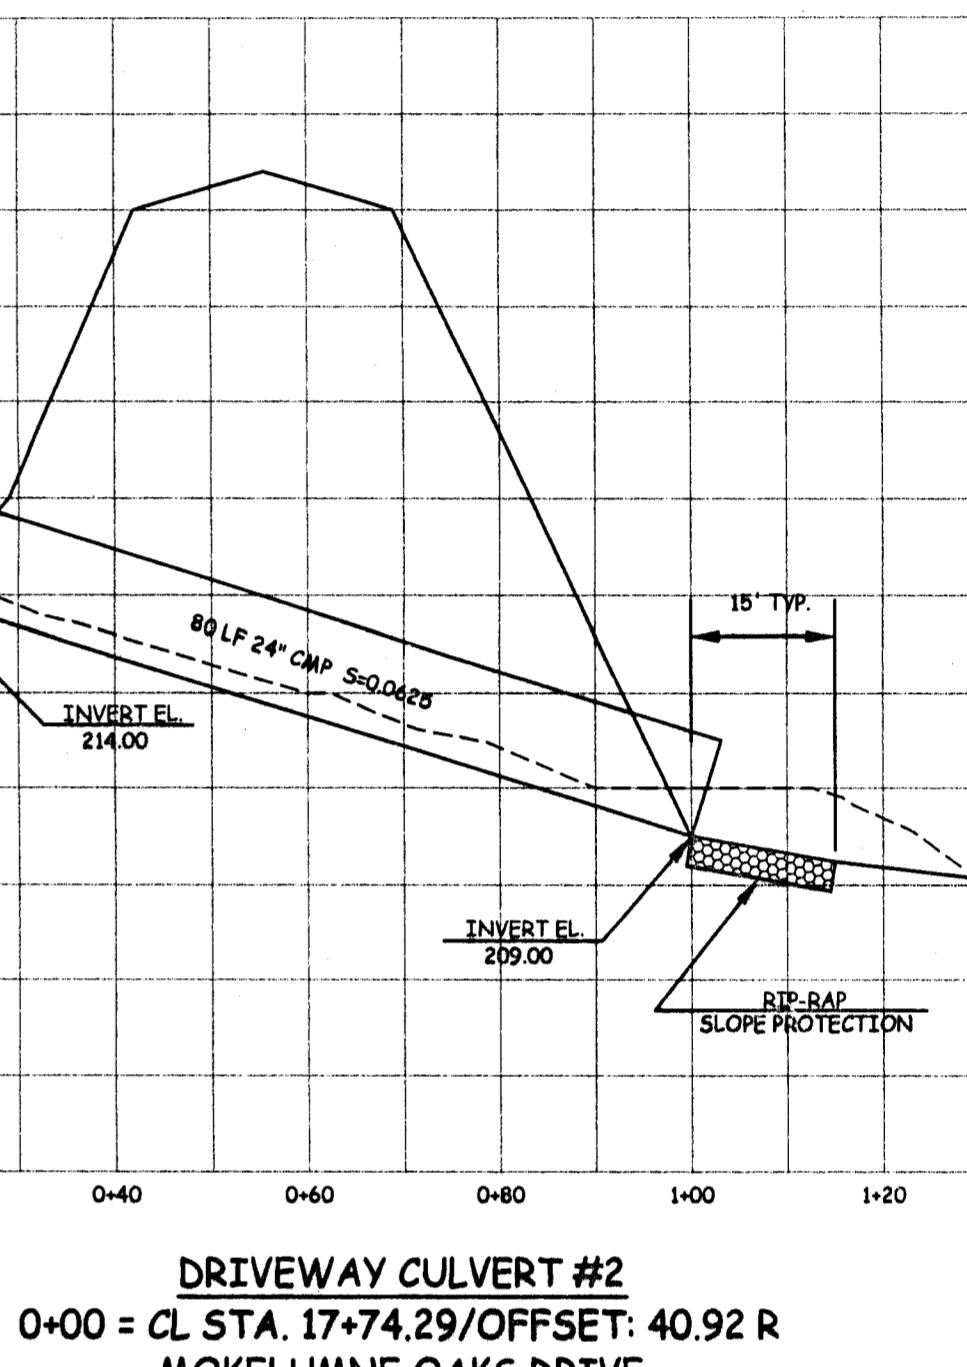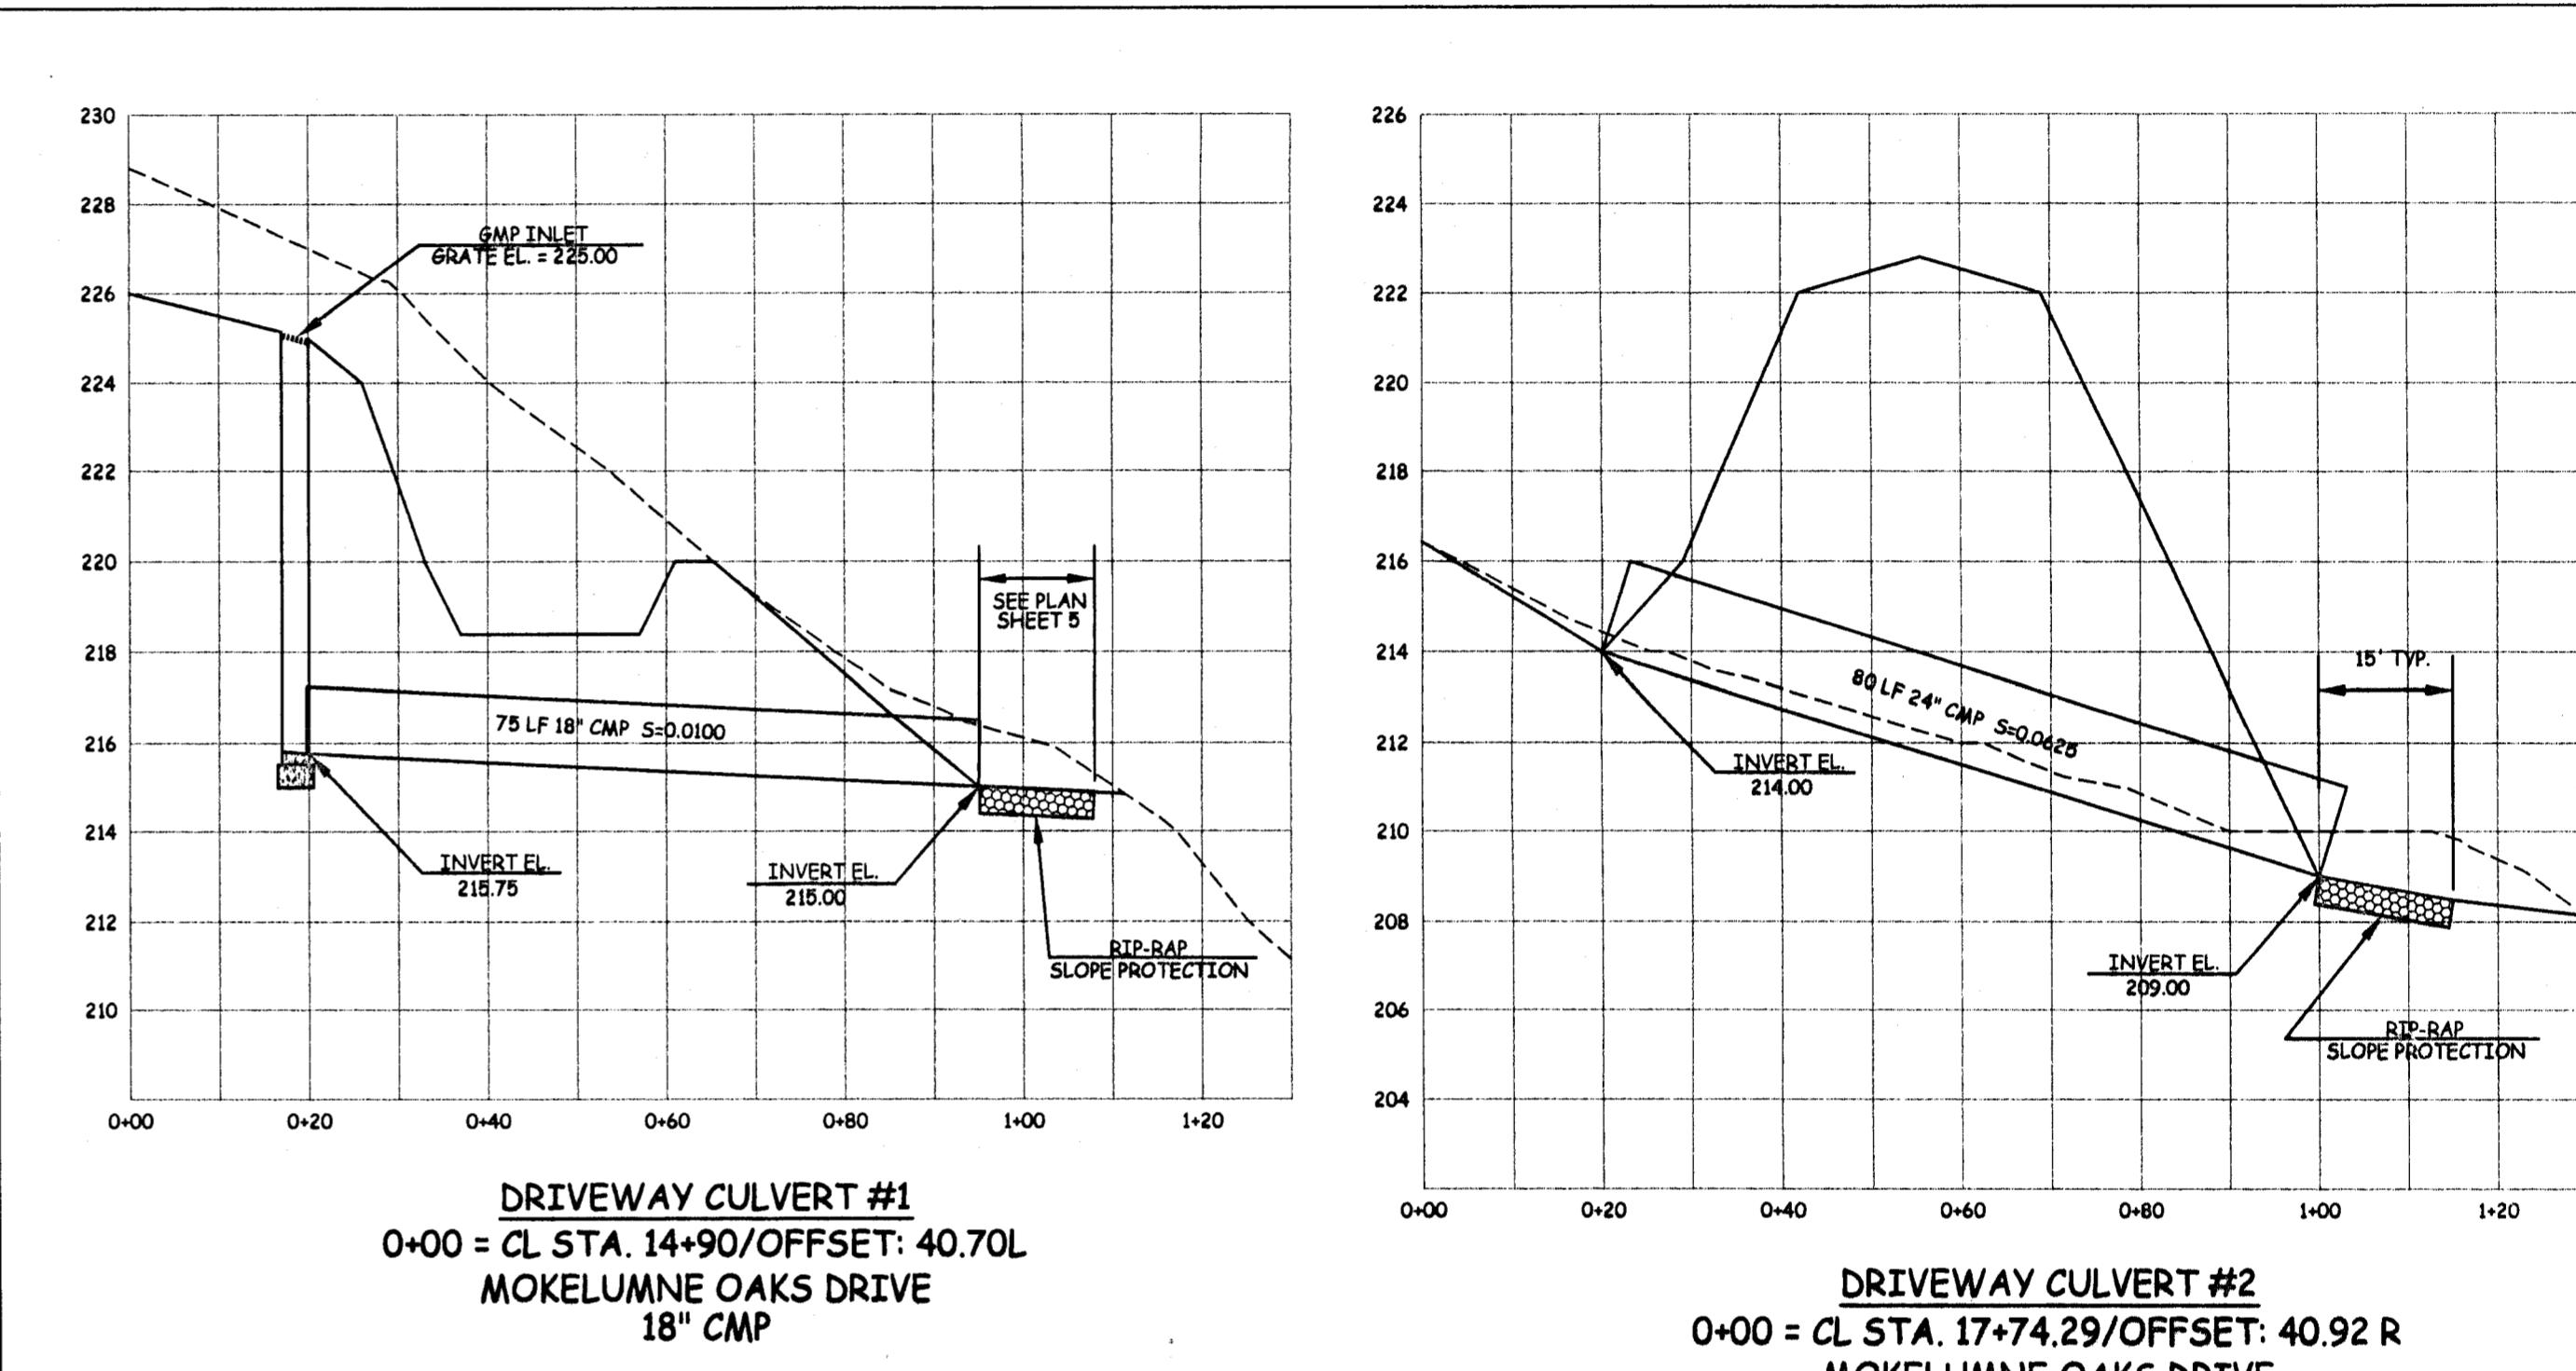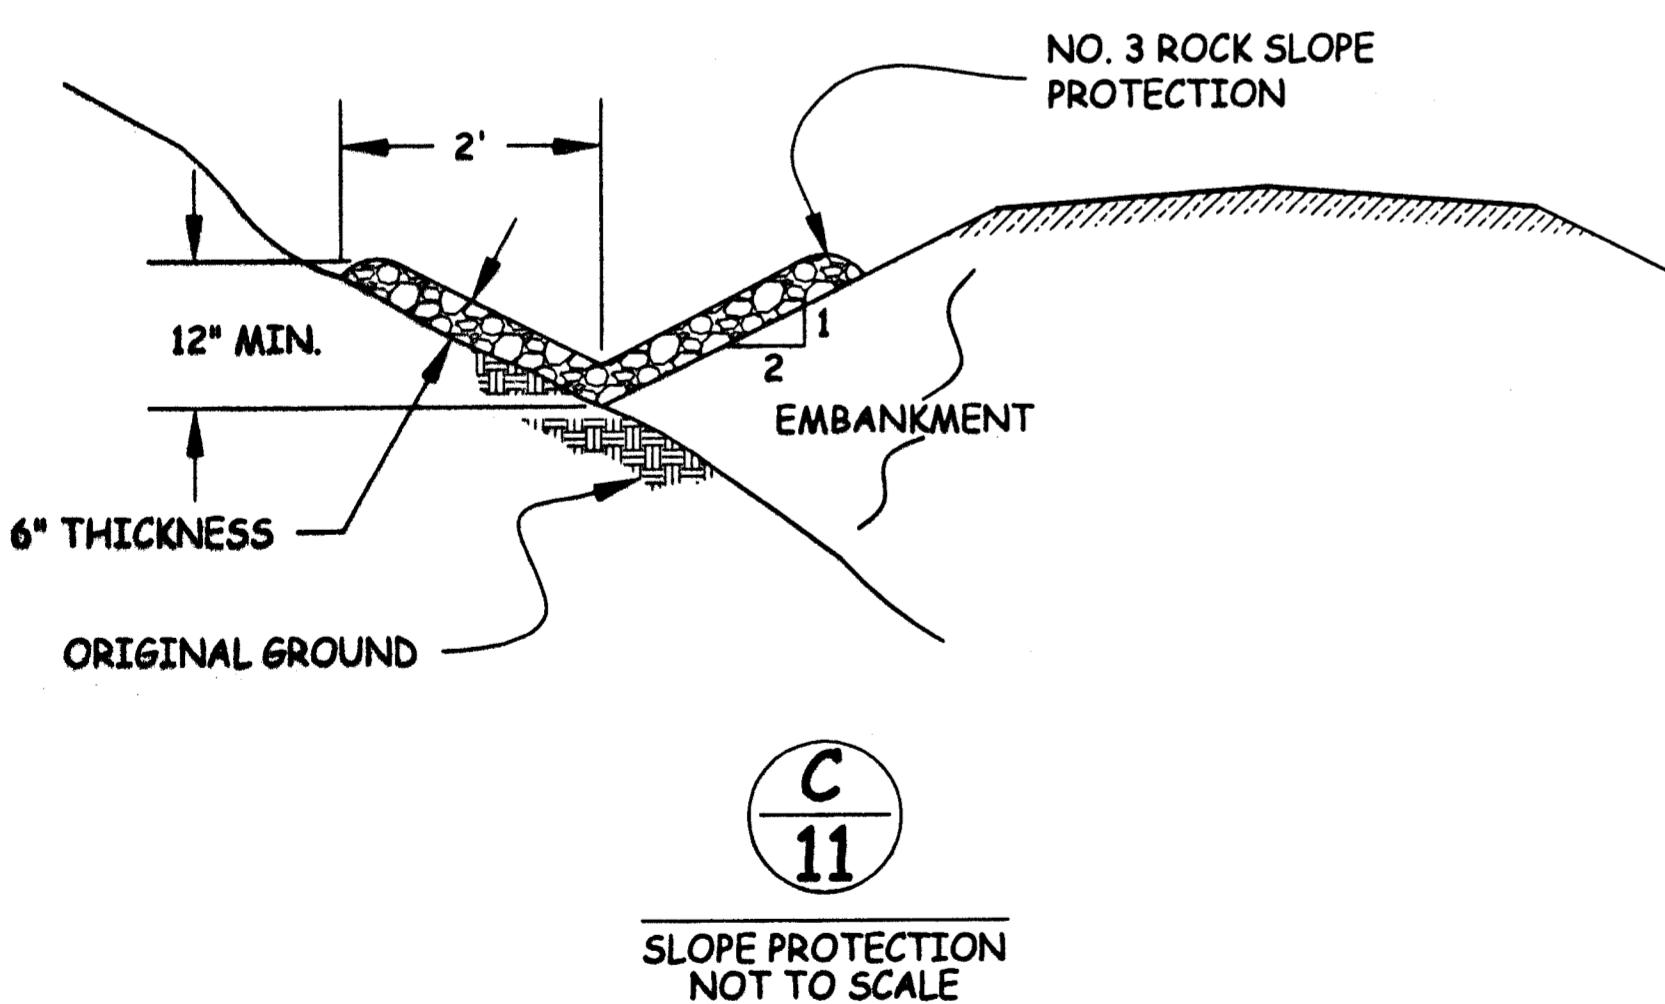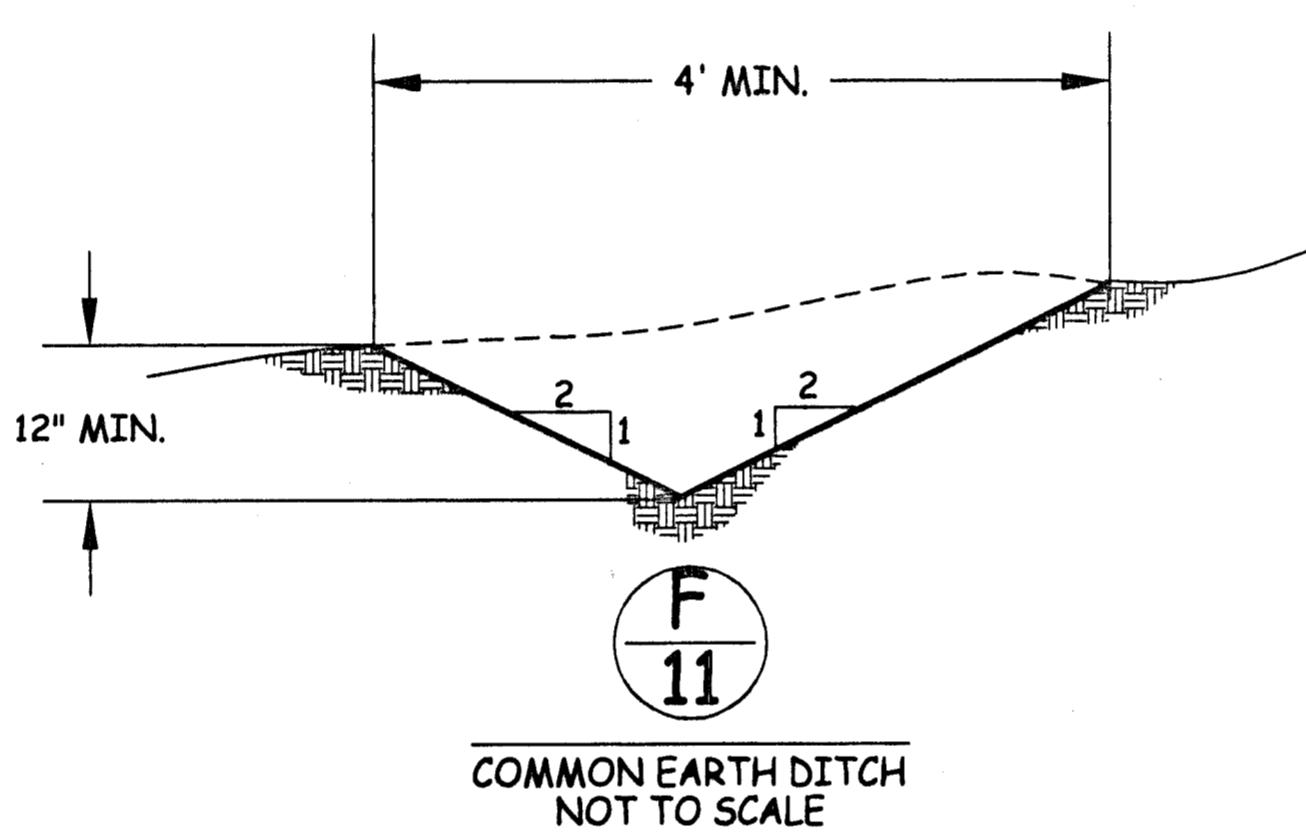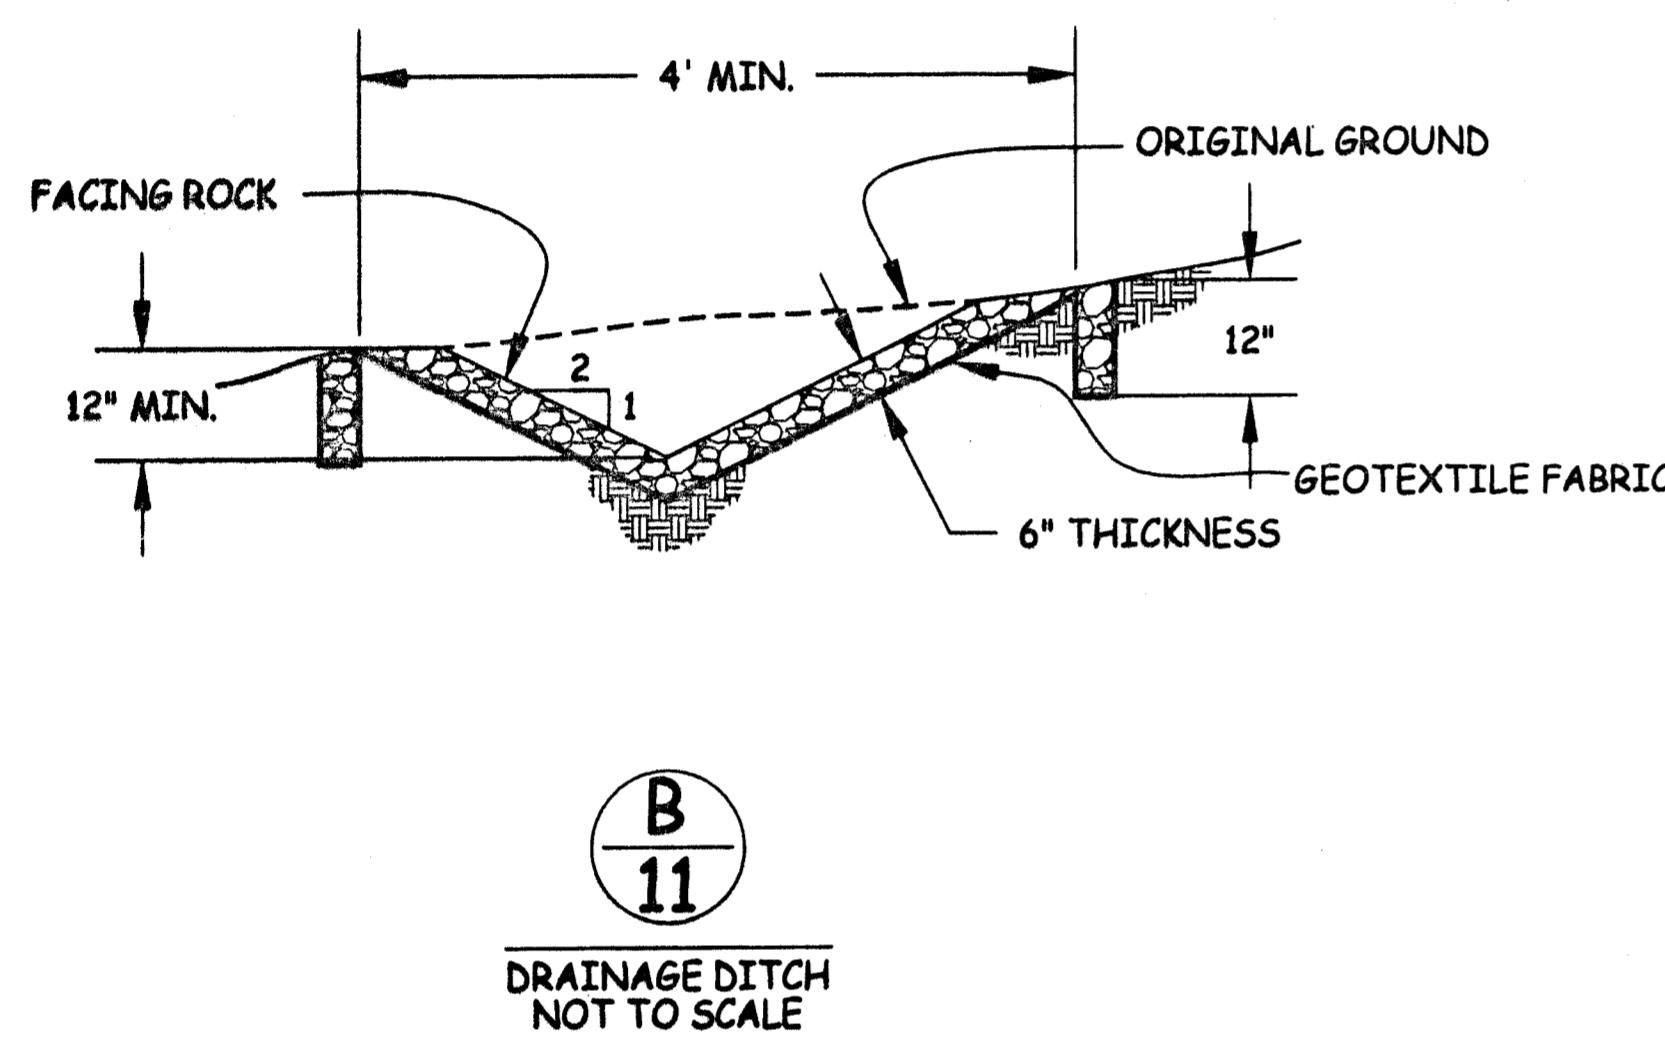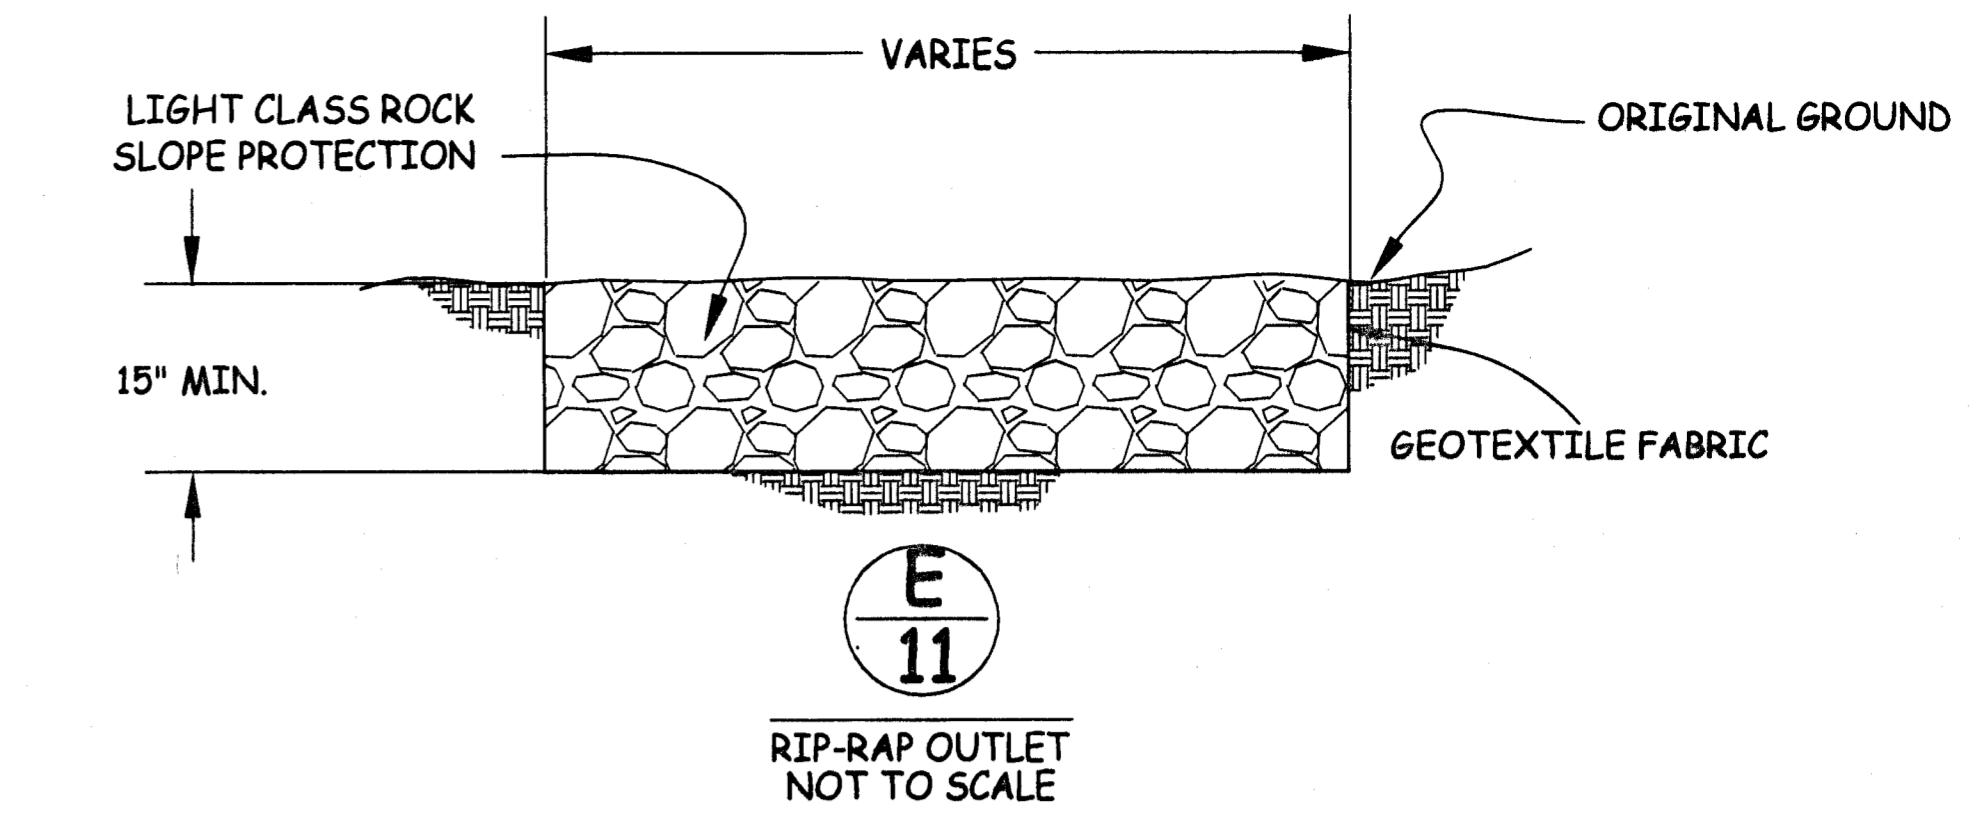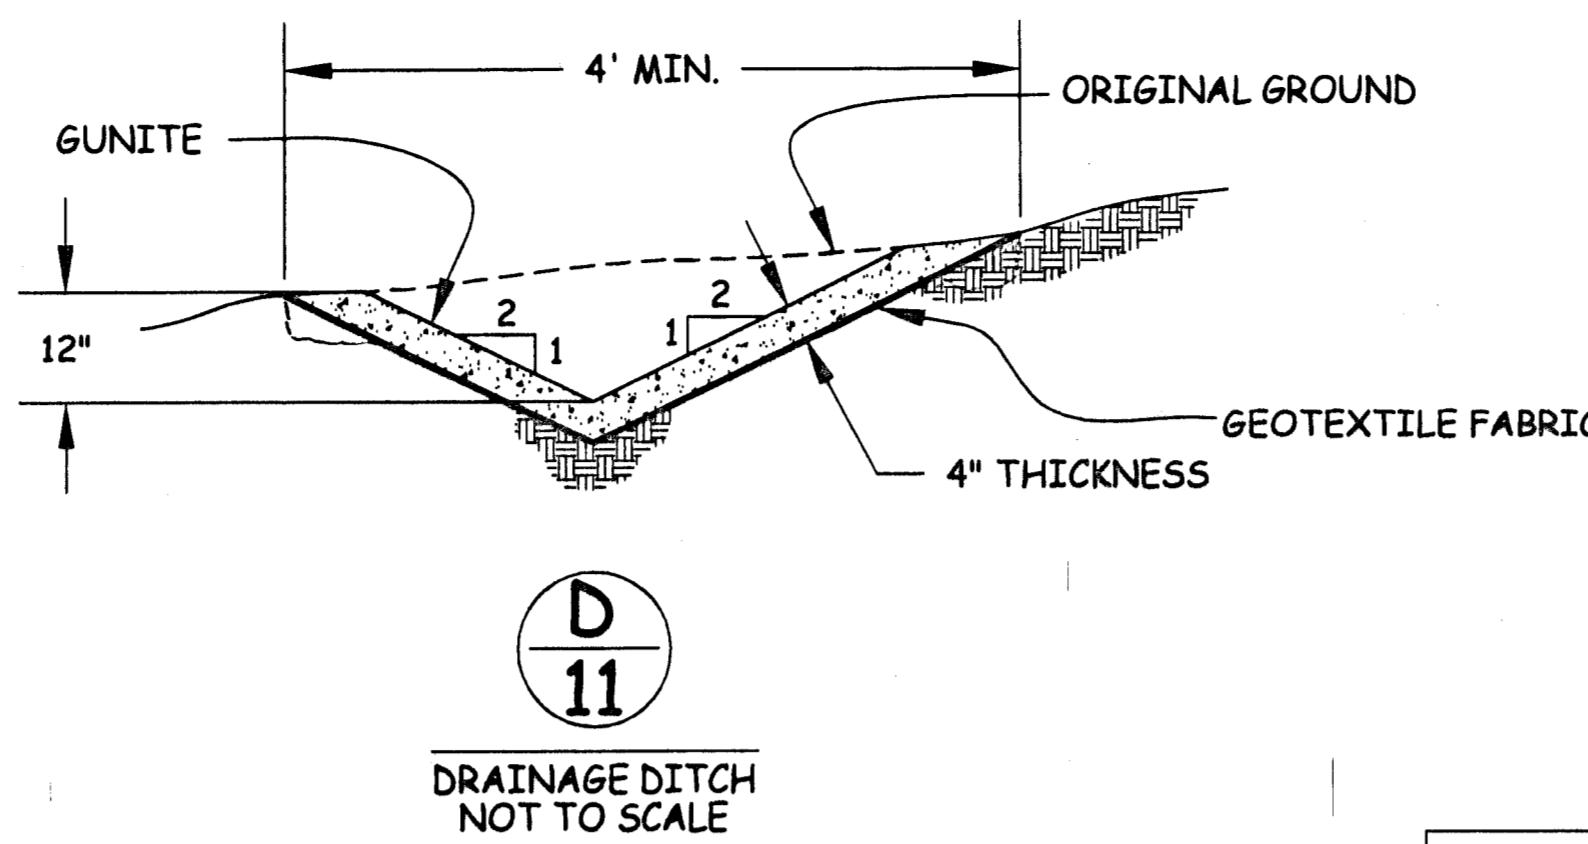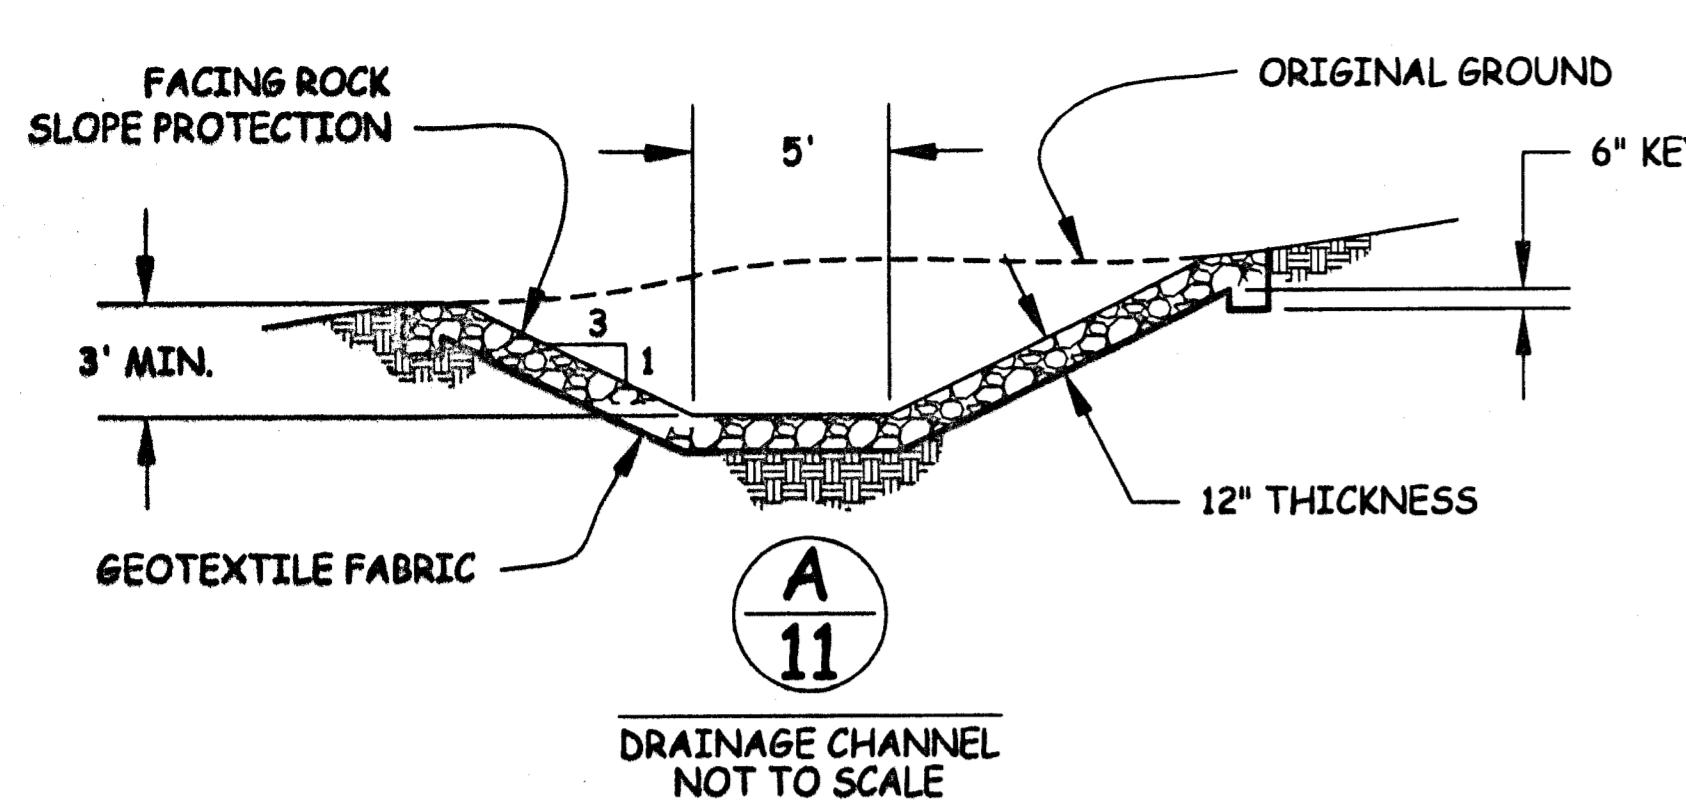
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Bernard T. Pedersen 2/6/04
BERNARD T. PEDERSEN





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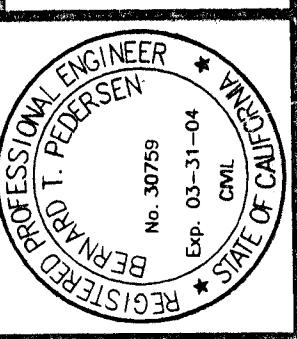
DETAILS & DRIVEWAY CULVERTS

MOKELOMNE OAKS SUBDIVISION

PROJECT # 0206-22
SHEET
11 OF 12


















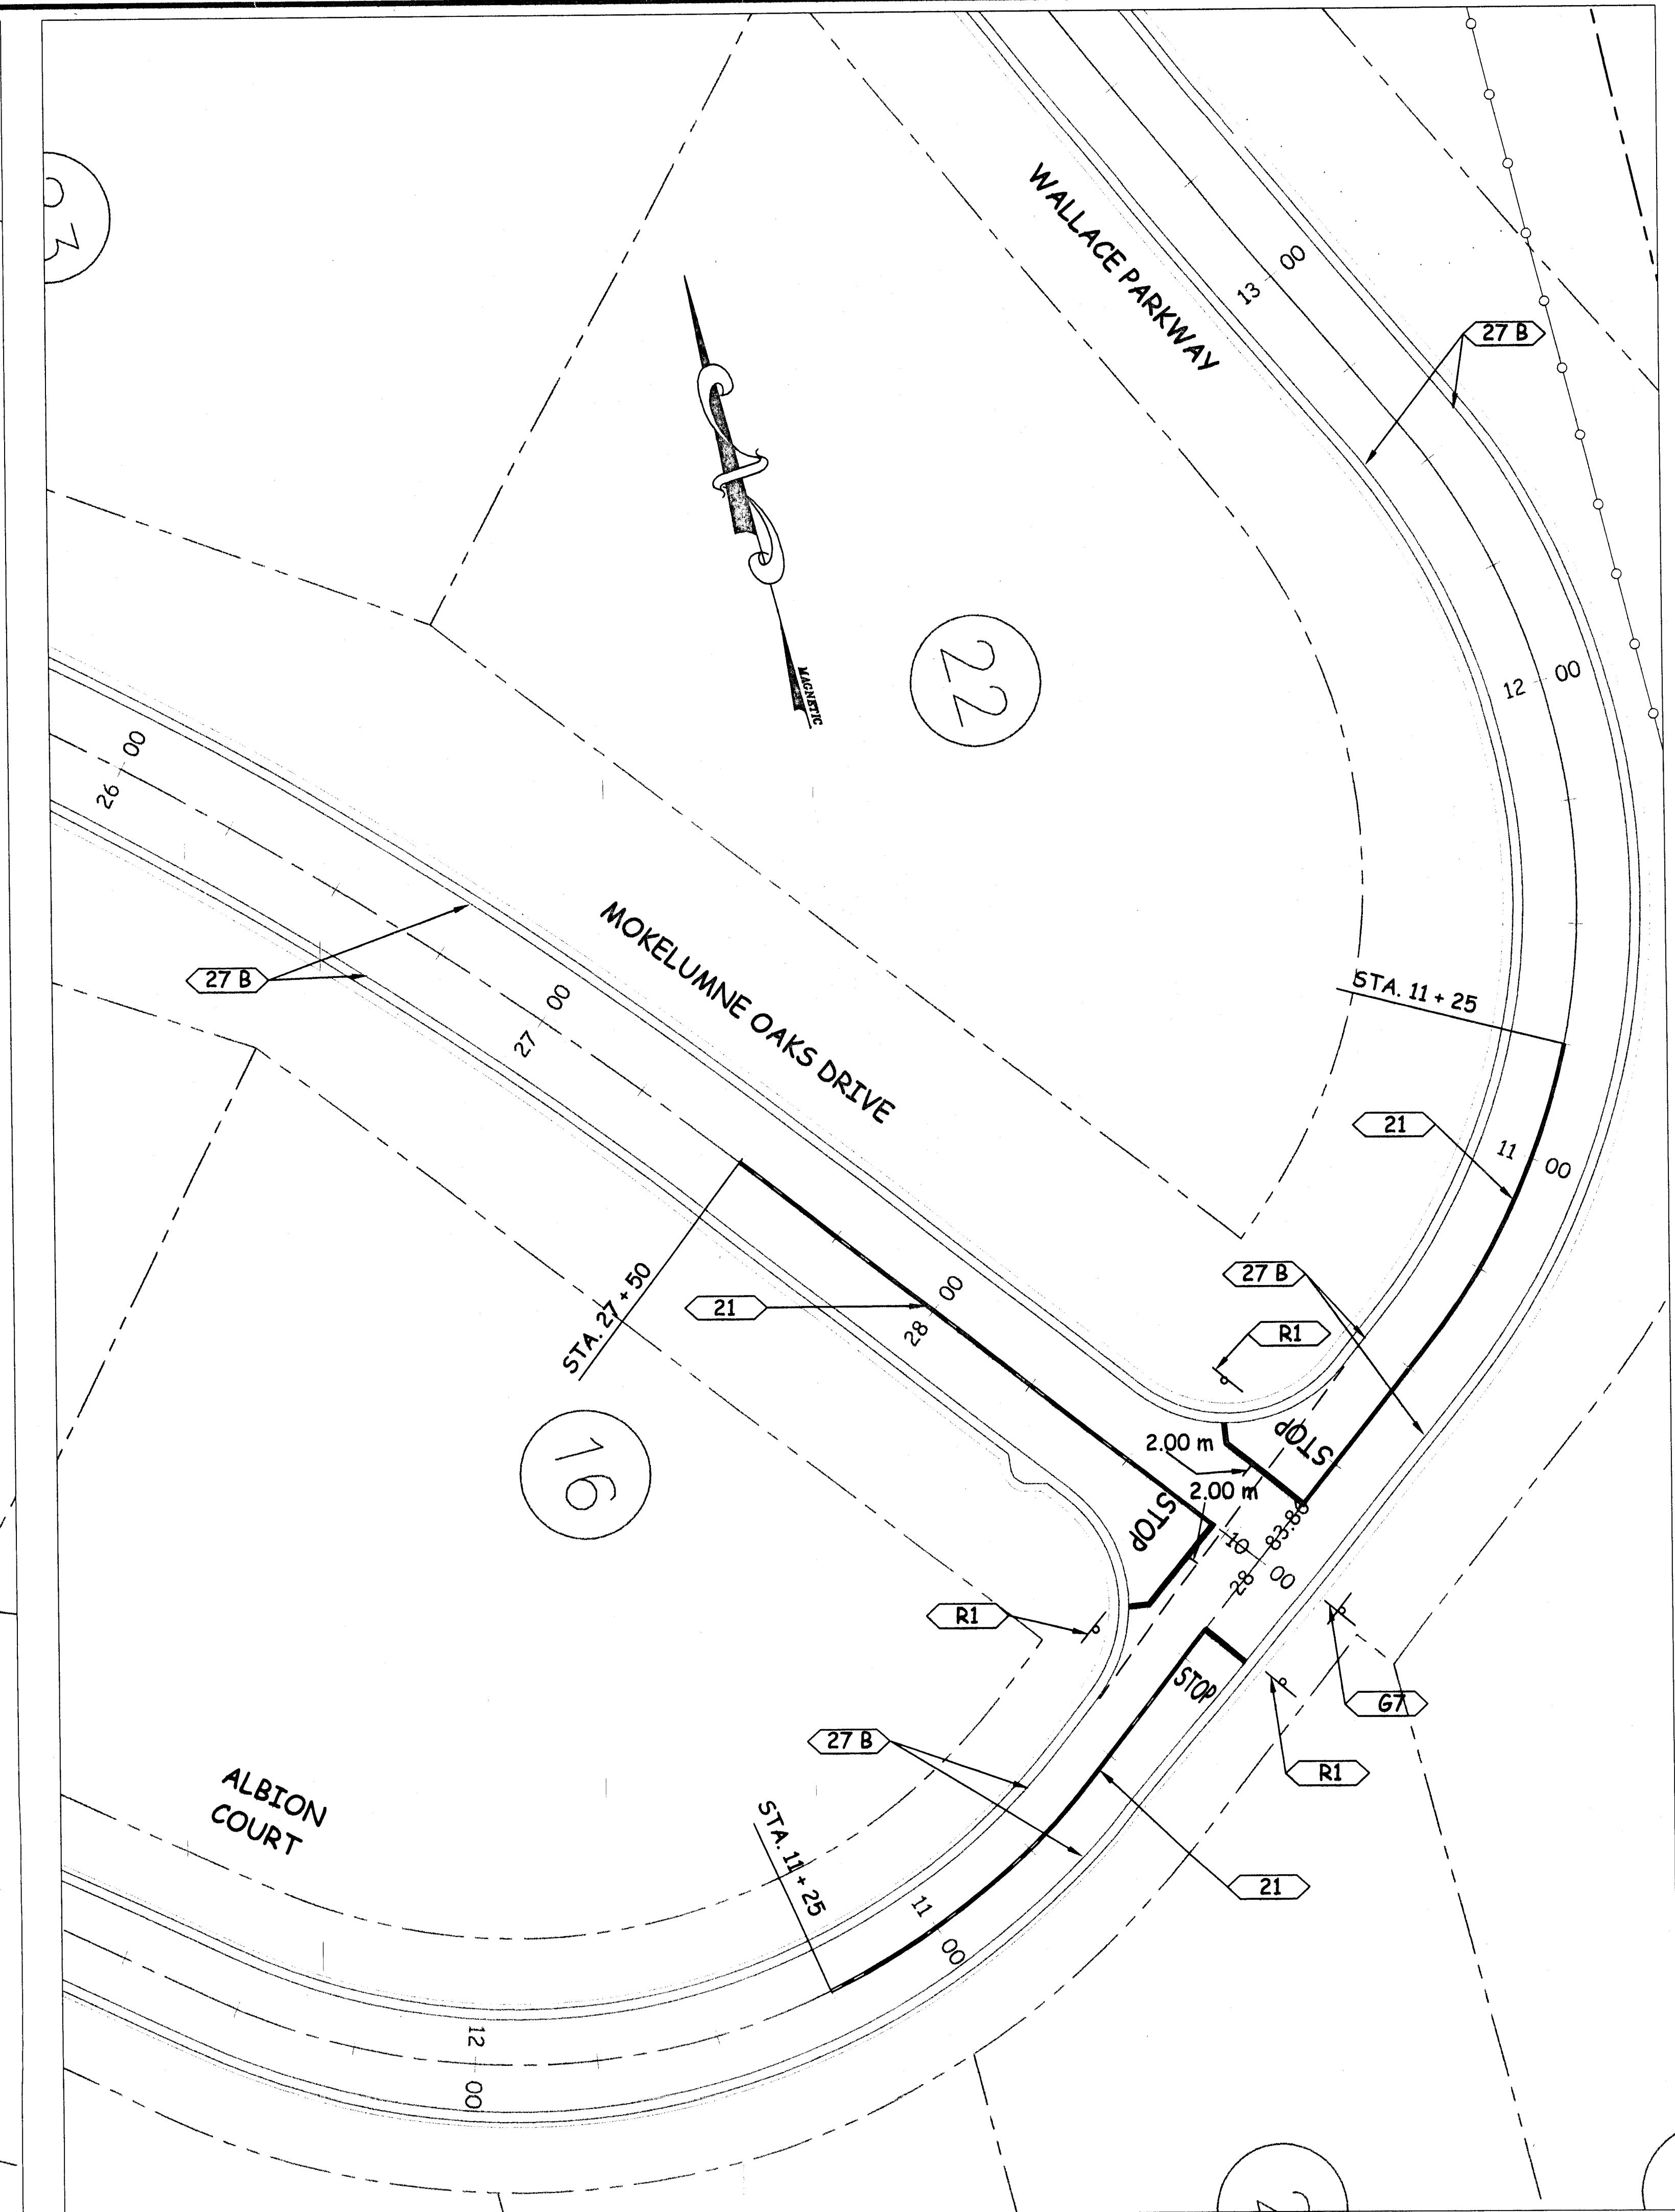
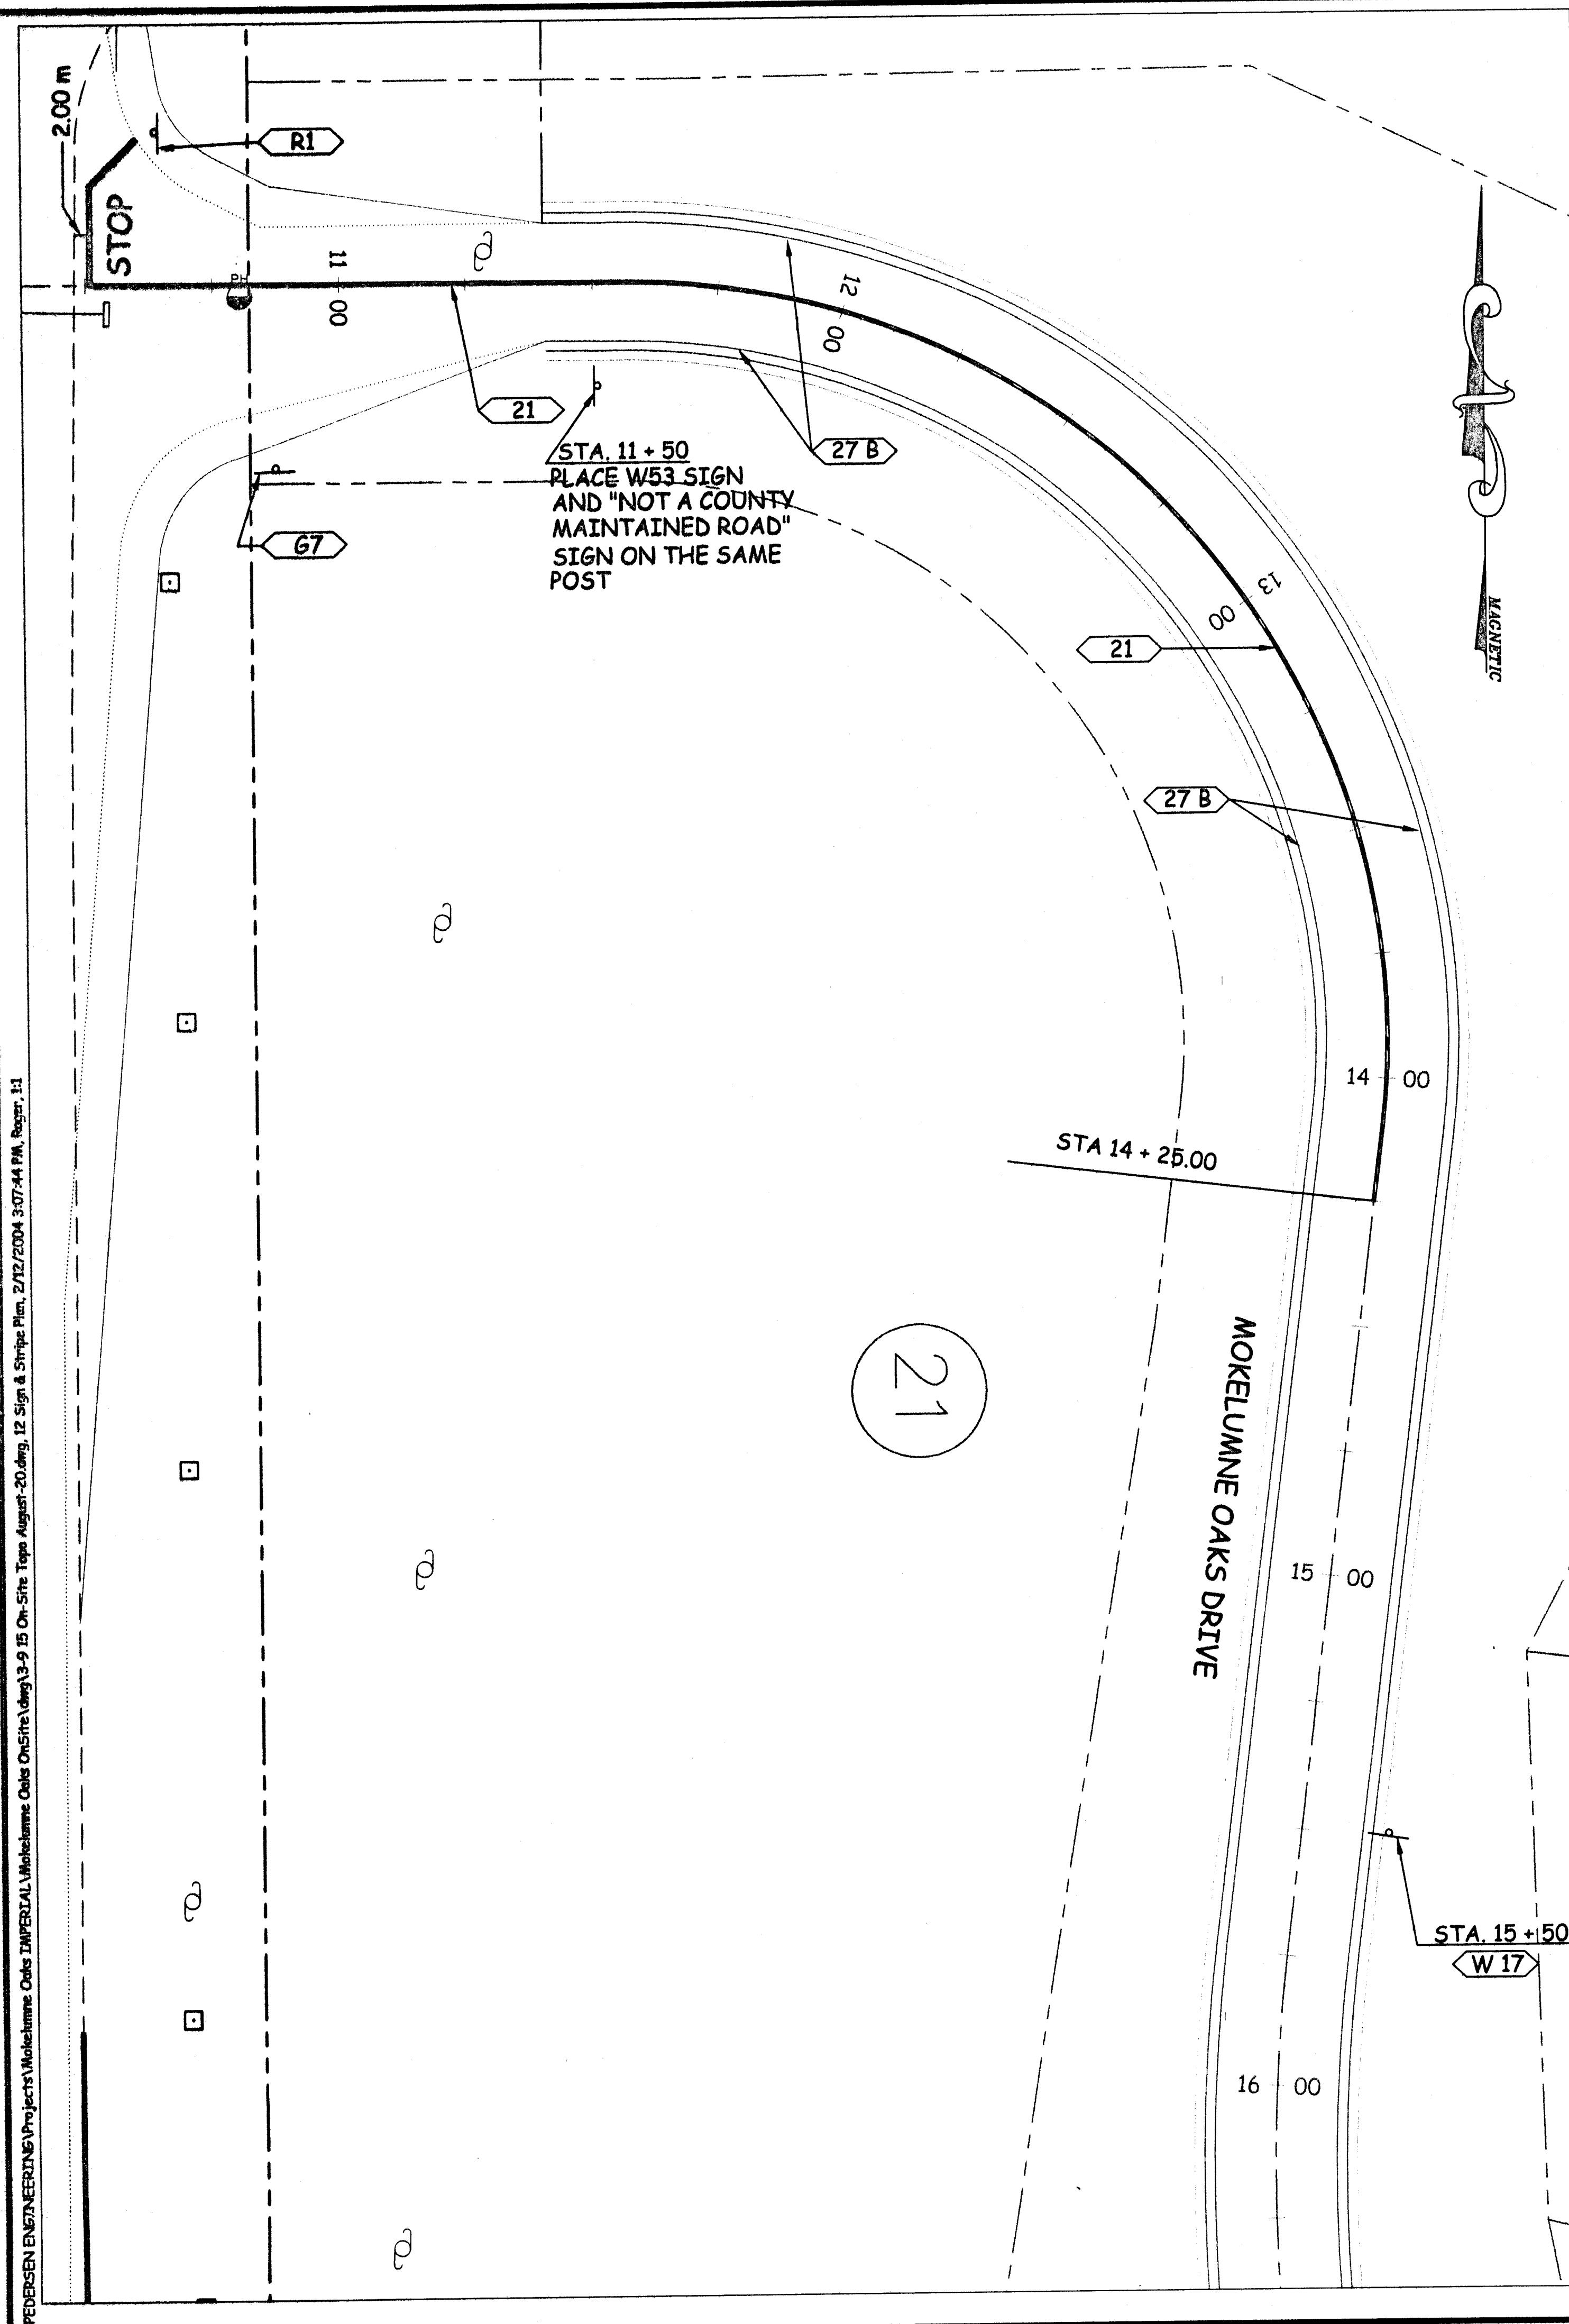


NO.	REVISION DESCRIPTION	DATE	BY:
FILE NAME:	Mokelumne Oaks OnSite/On-Site Topo	WORK ORDER NO.	
		0206-22/3A	



DATE:	8/28/03	
E:	H: 1" = 20'	
OWN:	R.S.	
GNED:	TP	
KED:	TP	
PREPARED UNDER THE DIRECTION OF:		
<u>Bernard T. Pedersen</u> 2/13/04		
BERNARD T. PEDERSEN		
DATE		


**SIGNING & STRIPPING PLAN
MOKE LUMNE OAKS
SUBDIVISION**

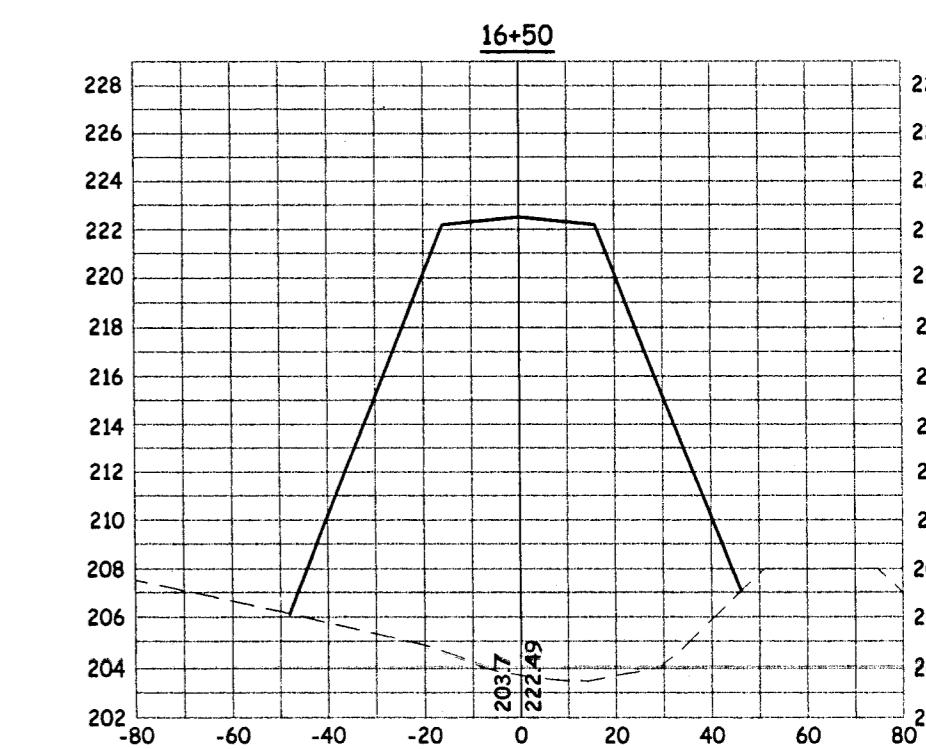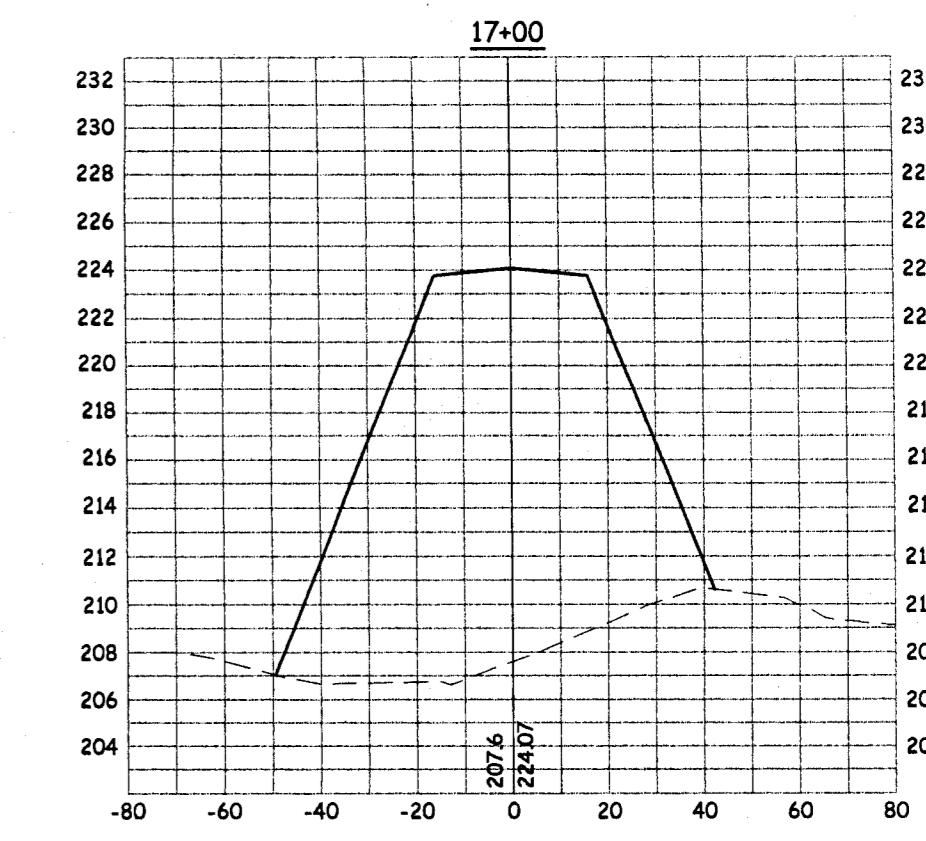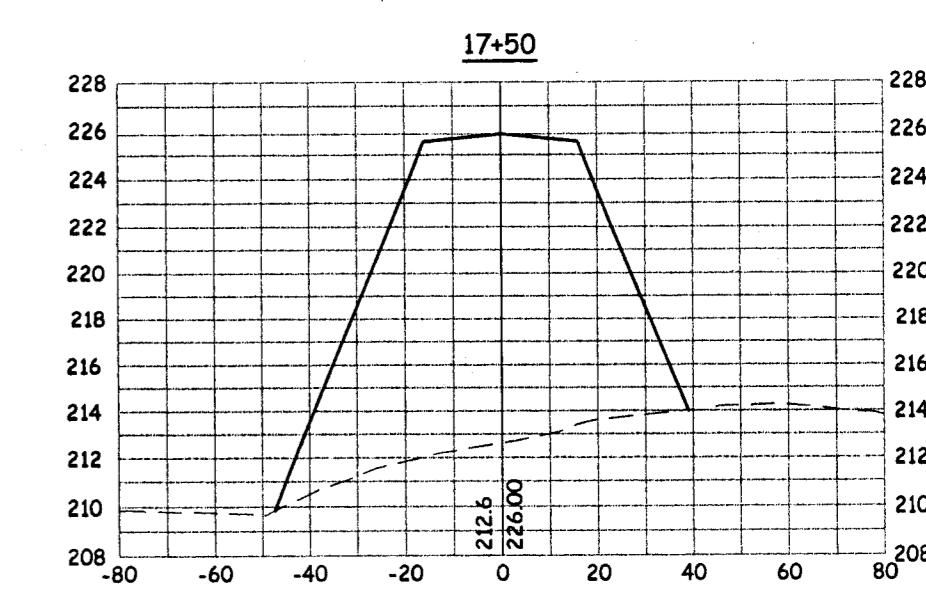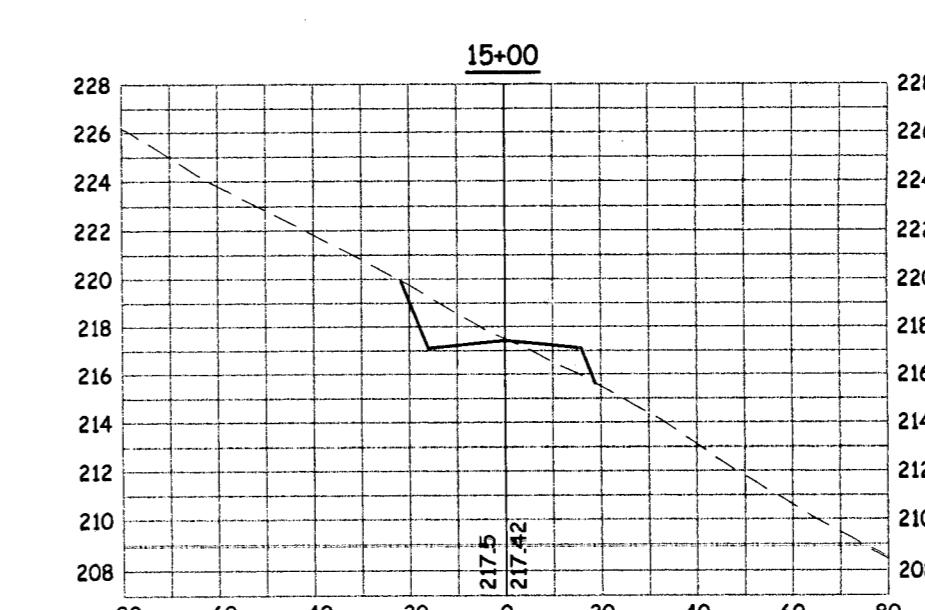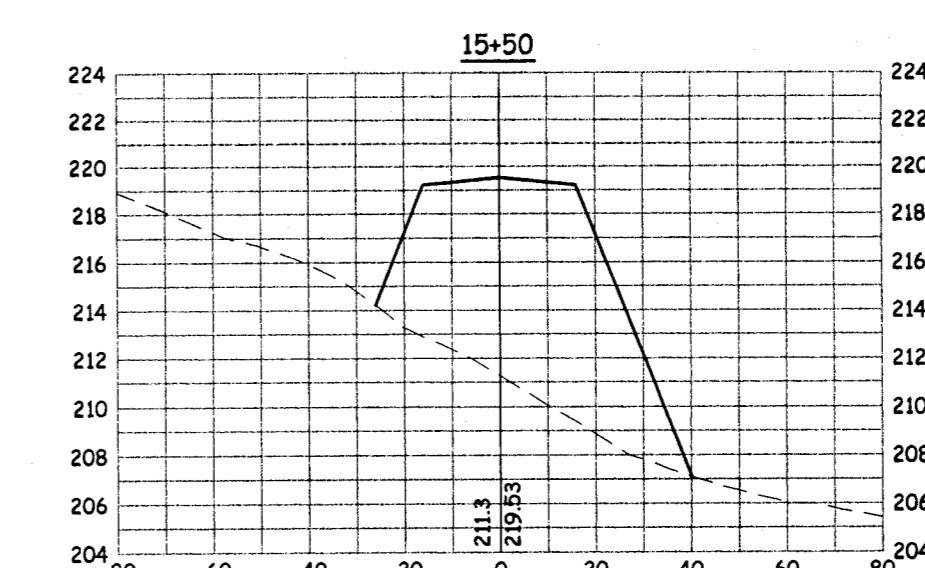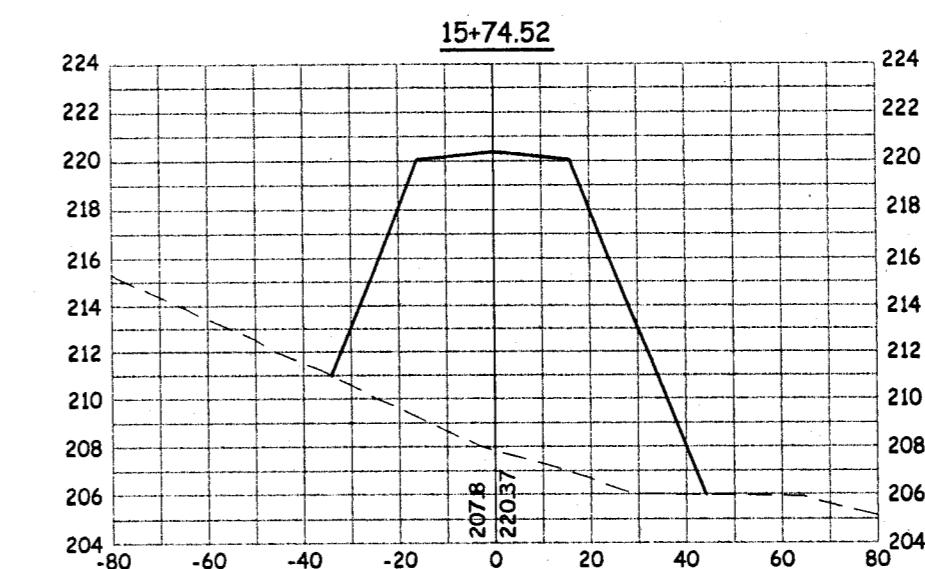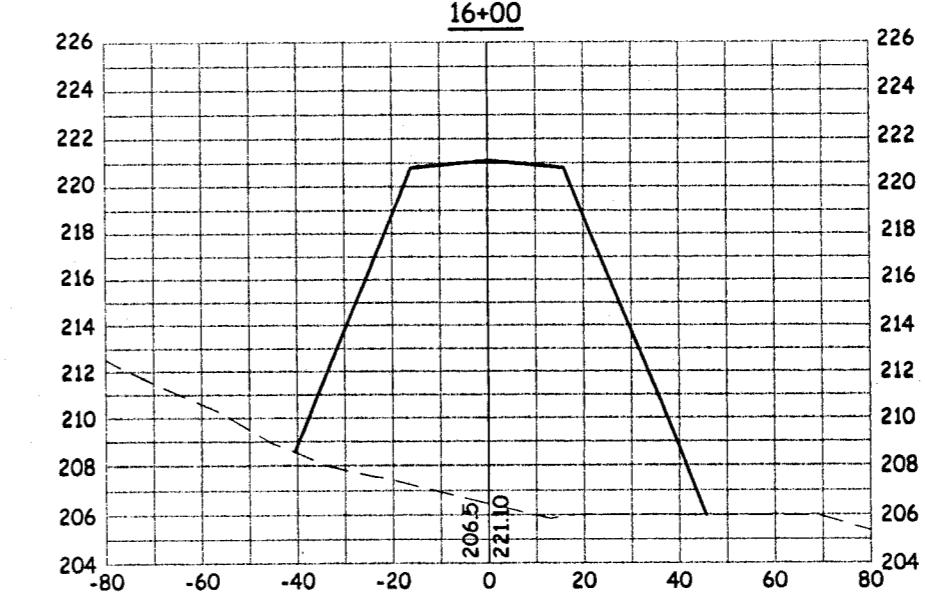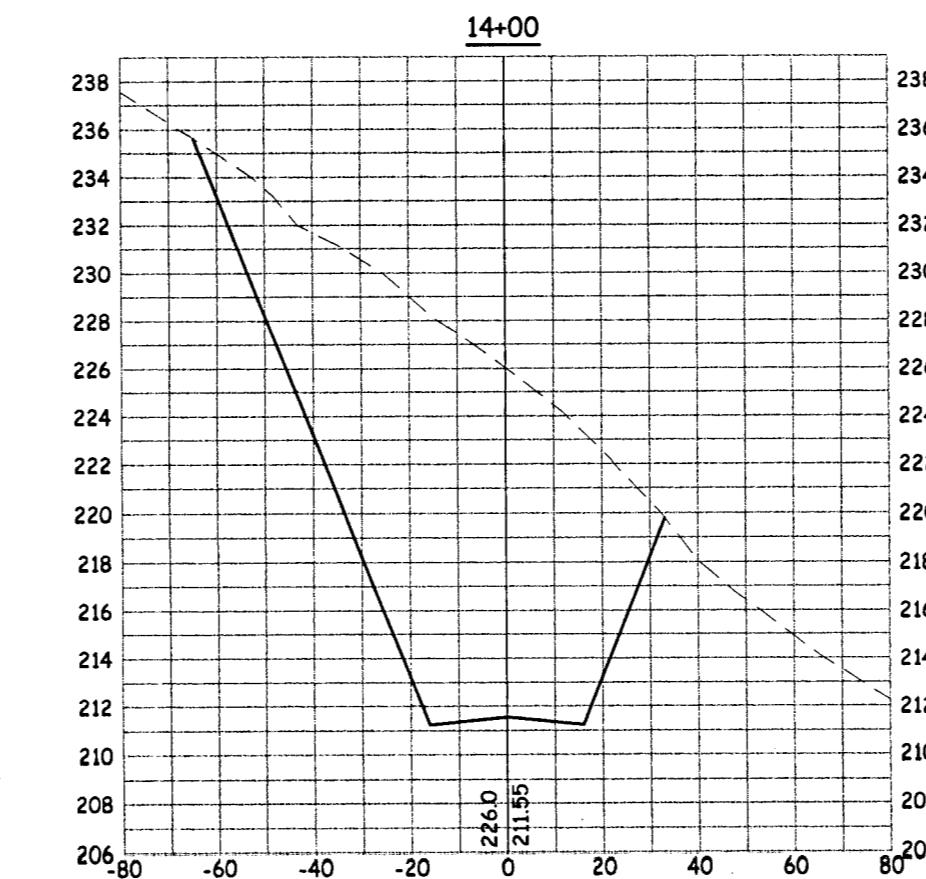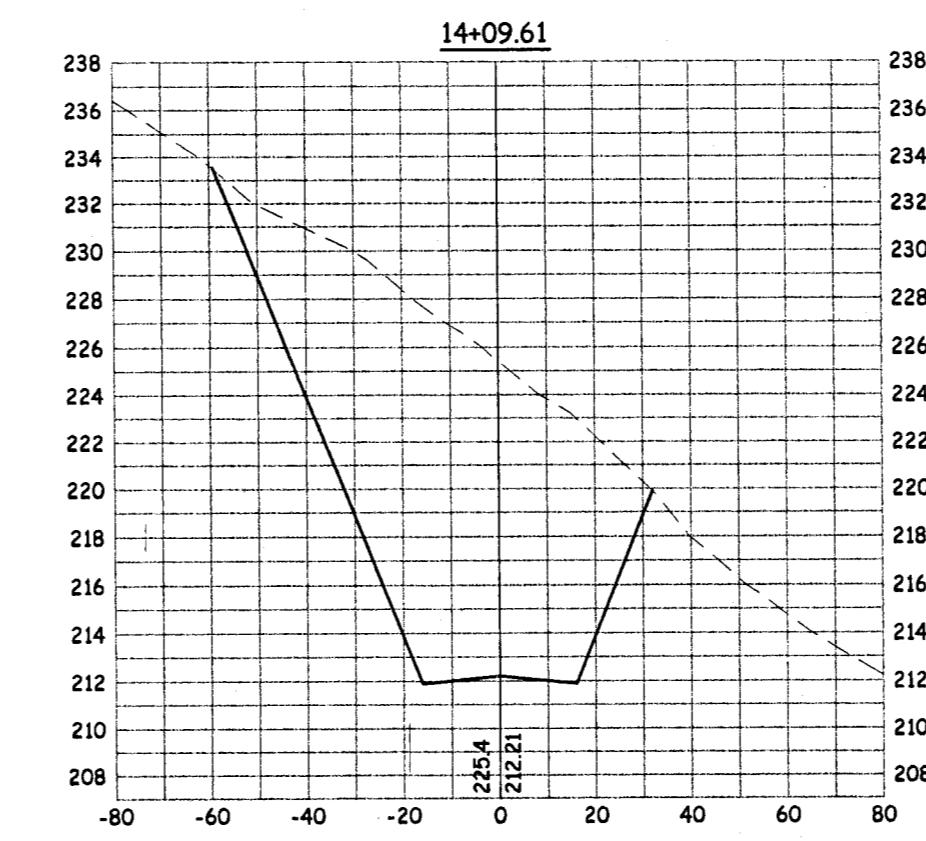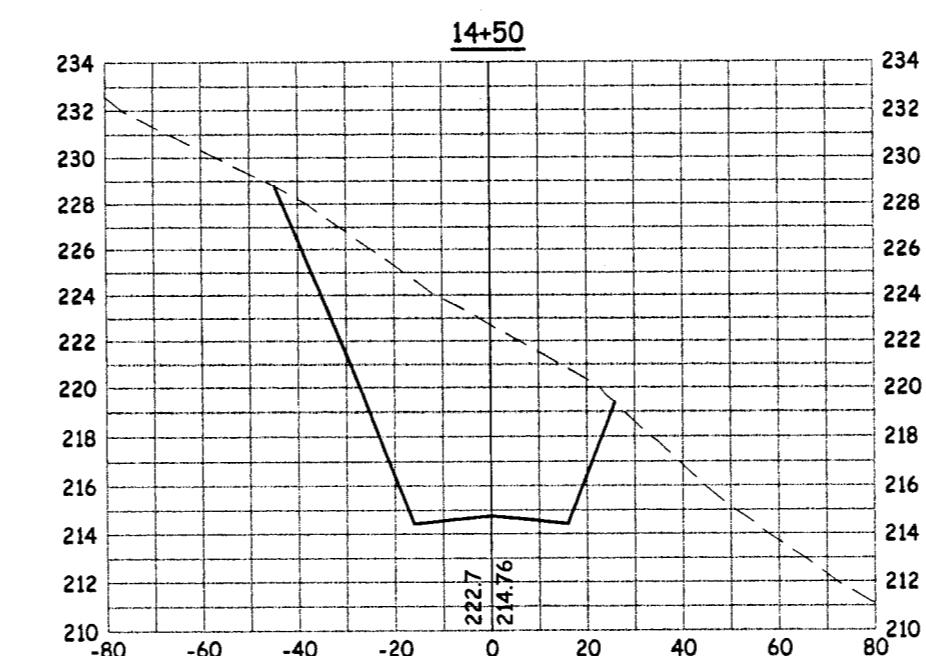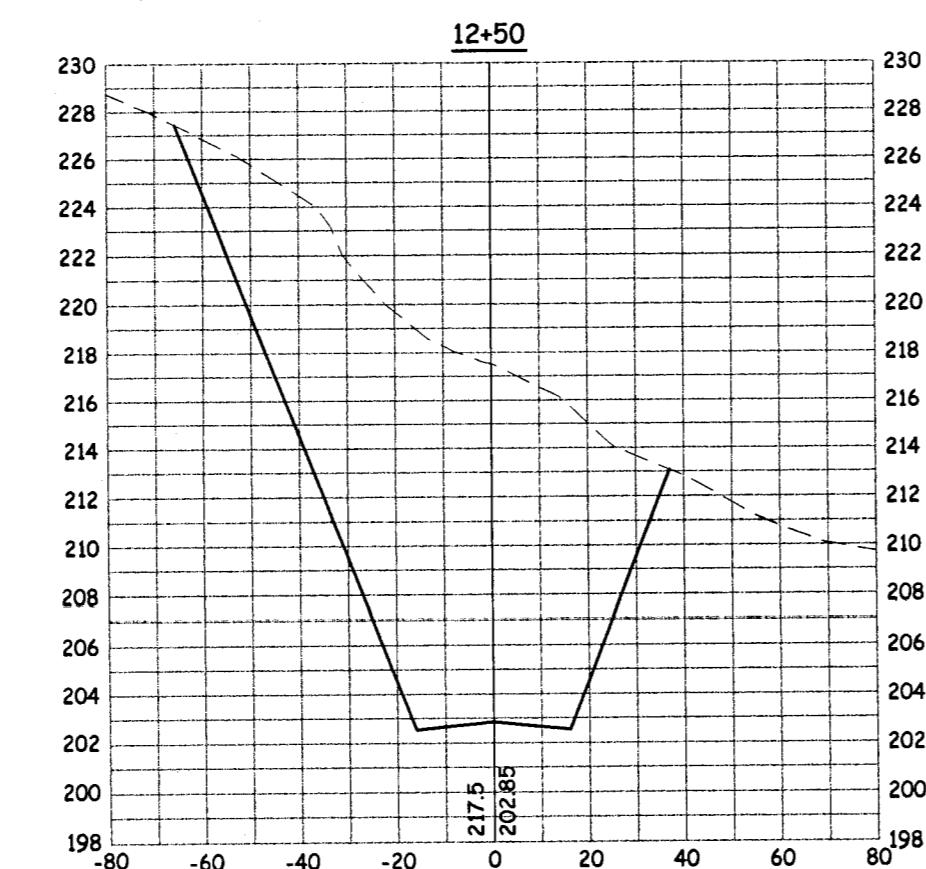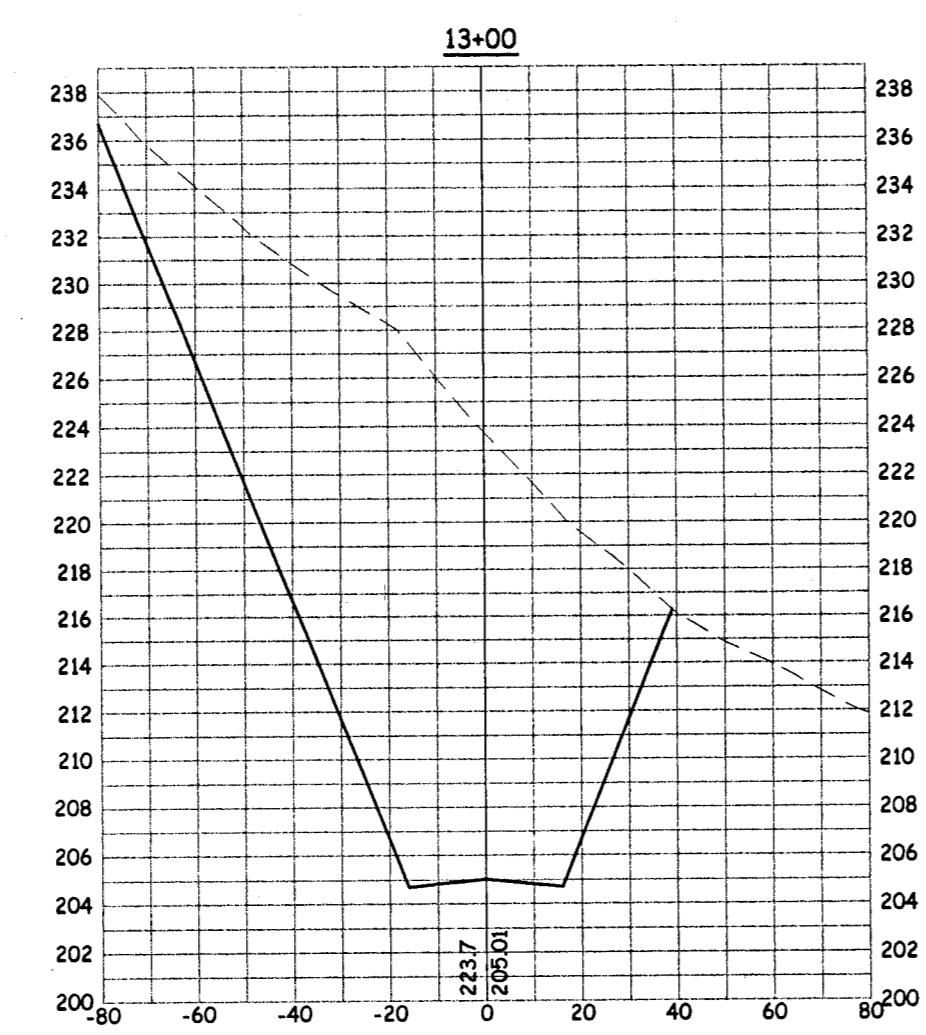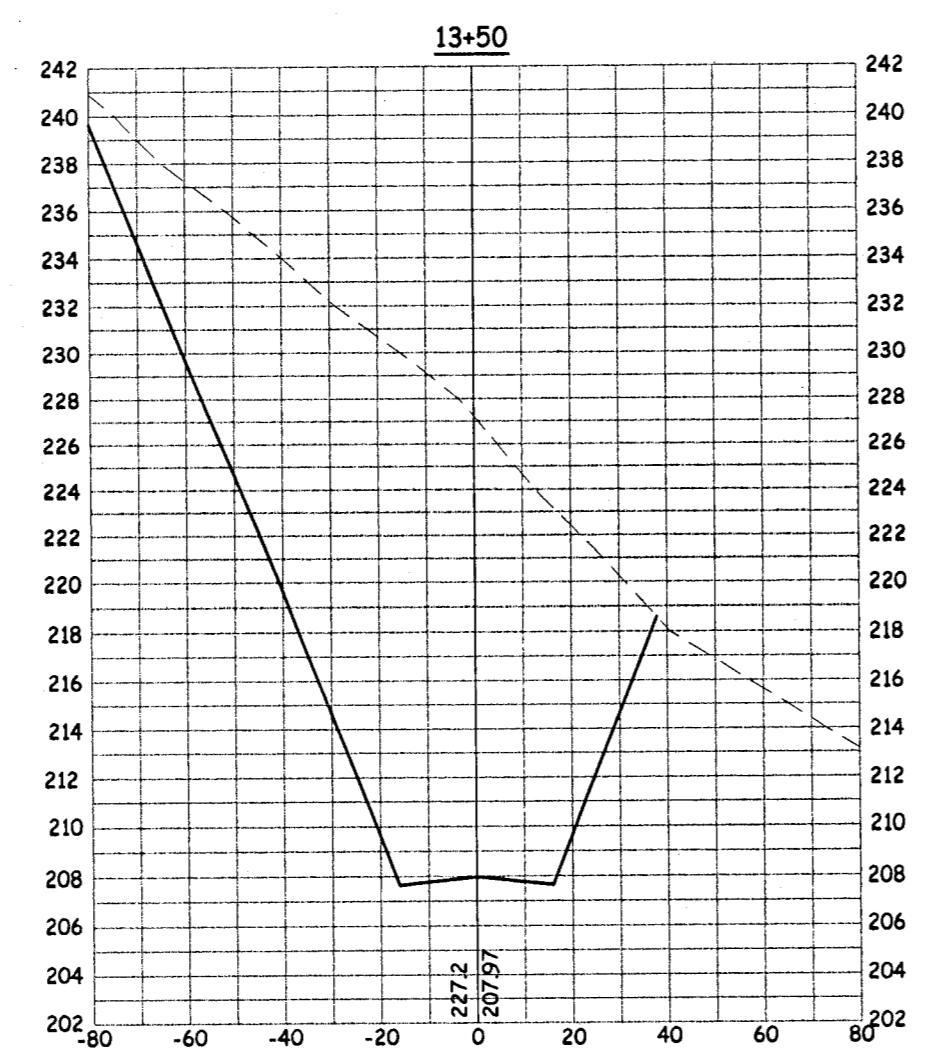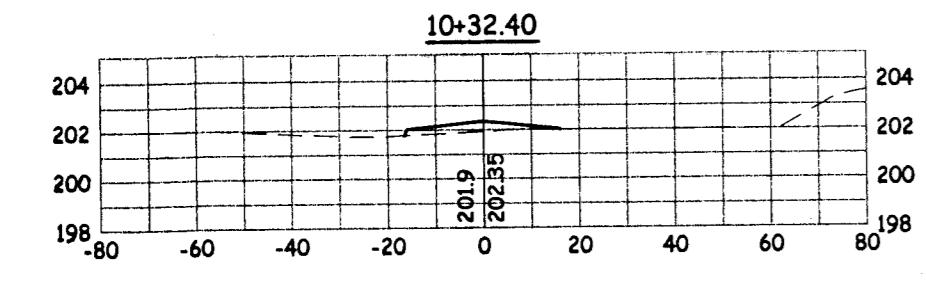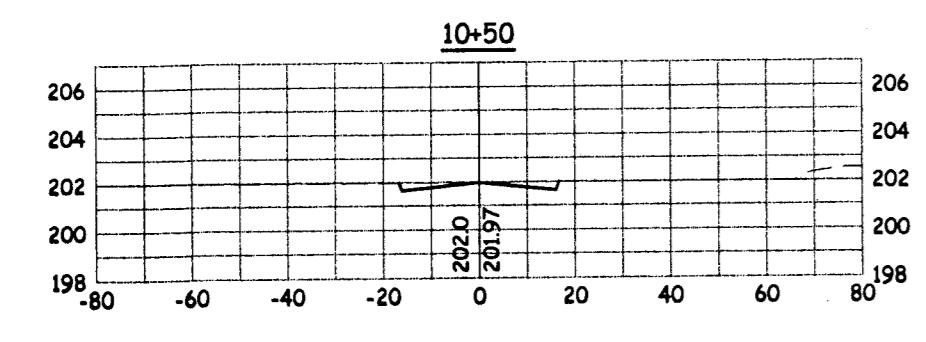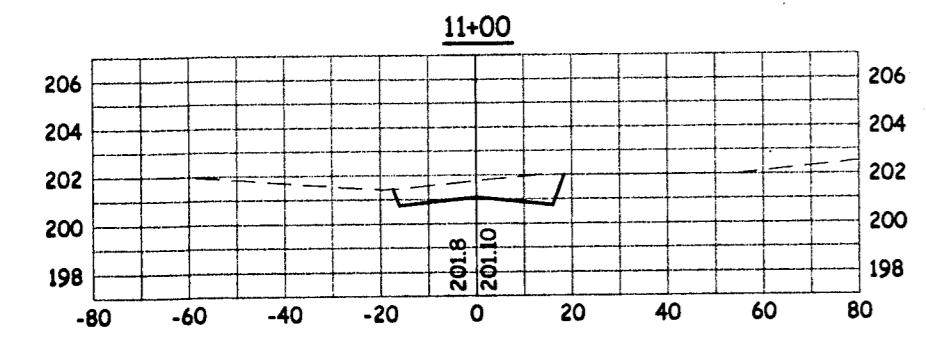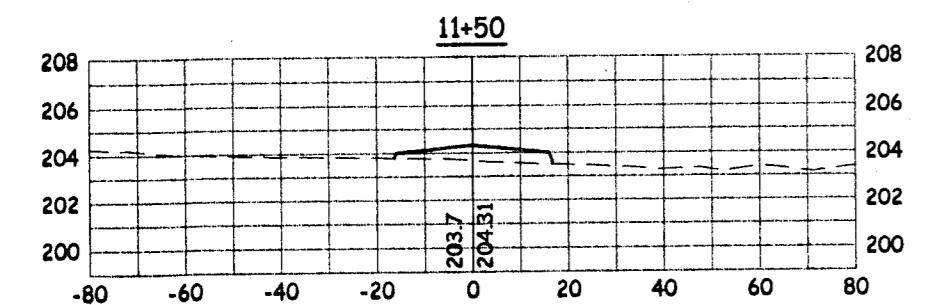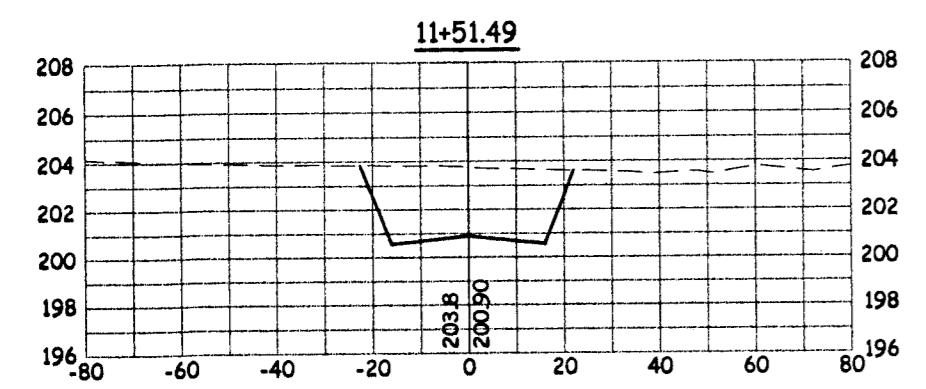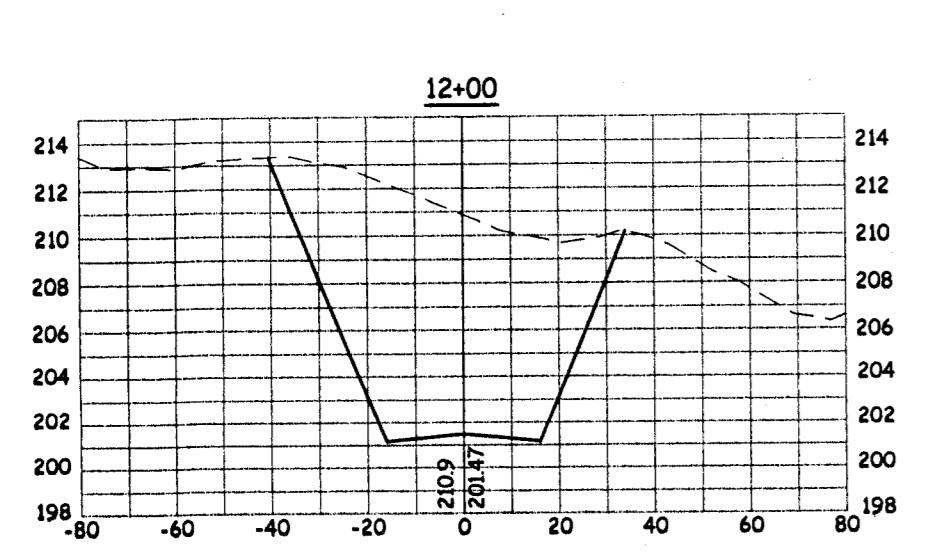

NO.	REVISION DESCRIPTION	BY:	DATE	APPROVED BY:
			8/28/03	

SCALE: H:1'=40' / V:1'=8'
DRAWN: RLS
DESIGNED: TP
CHECKED: TP


PREPARED UNDER THE DIRECTION OF:
BERNARD T. PEDERSEN DATE

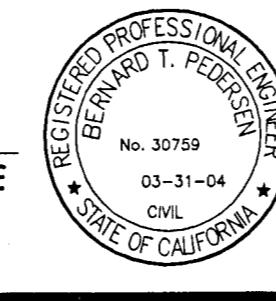

Pedersen Engineering Inc.
Consulting Civil Engineers
P.O. Box 668, San Andreas, Ca. 95249
Phone (209) 754-4205
Fax (209) 754-0139

CROSS SECTIONS - MOKELUMNE OAKS DRIVE MOKELUMNE OAKS SUBDIVISION


PROJECT # 0206-22
SHEET X1 of 7

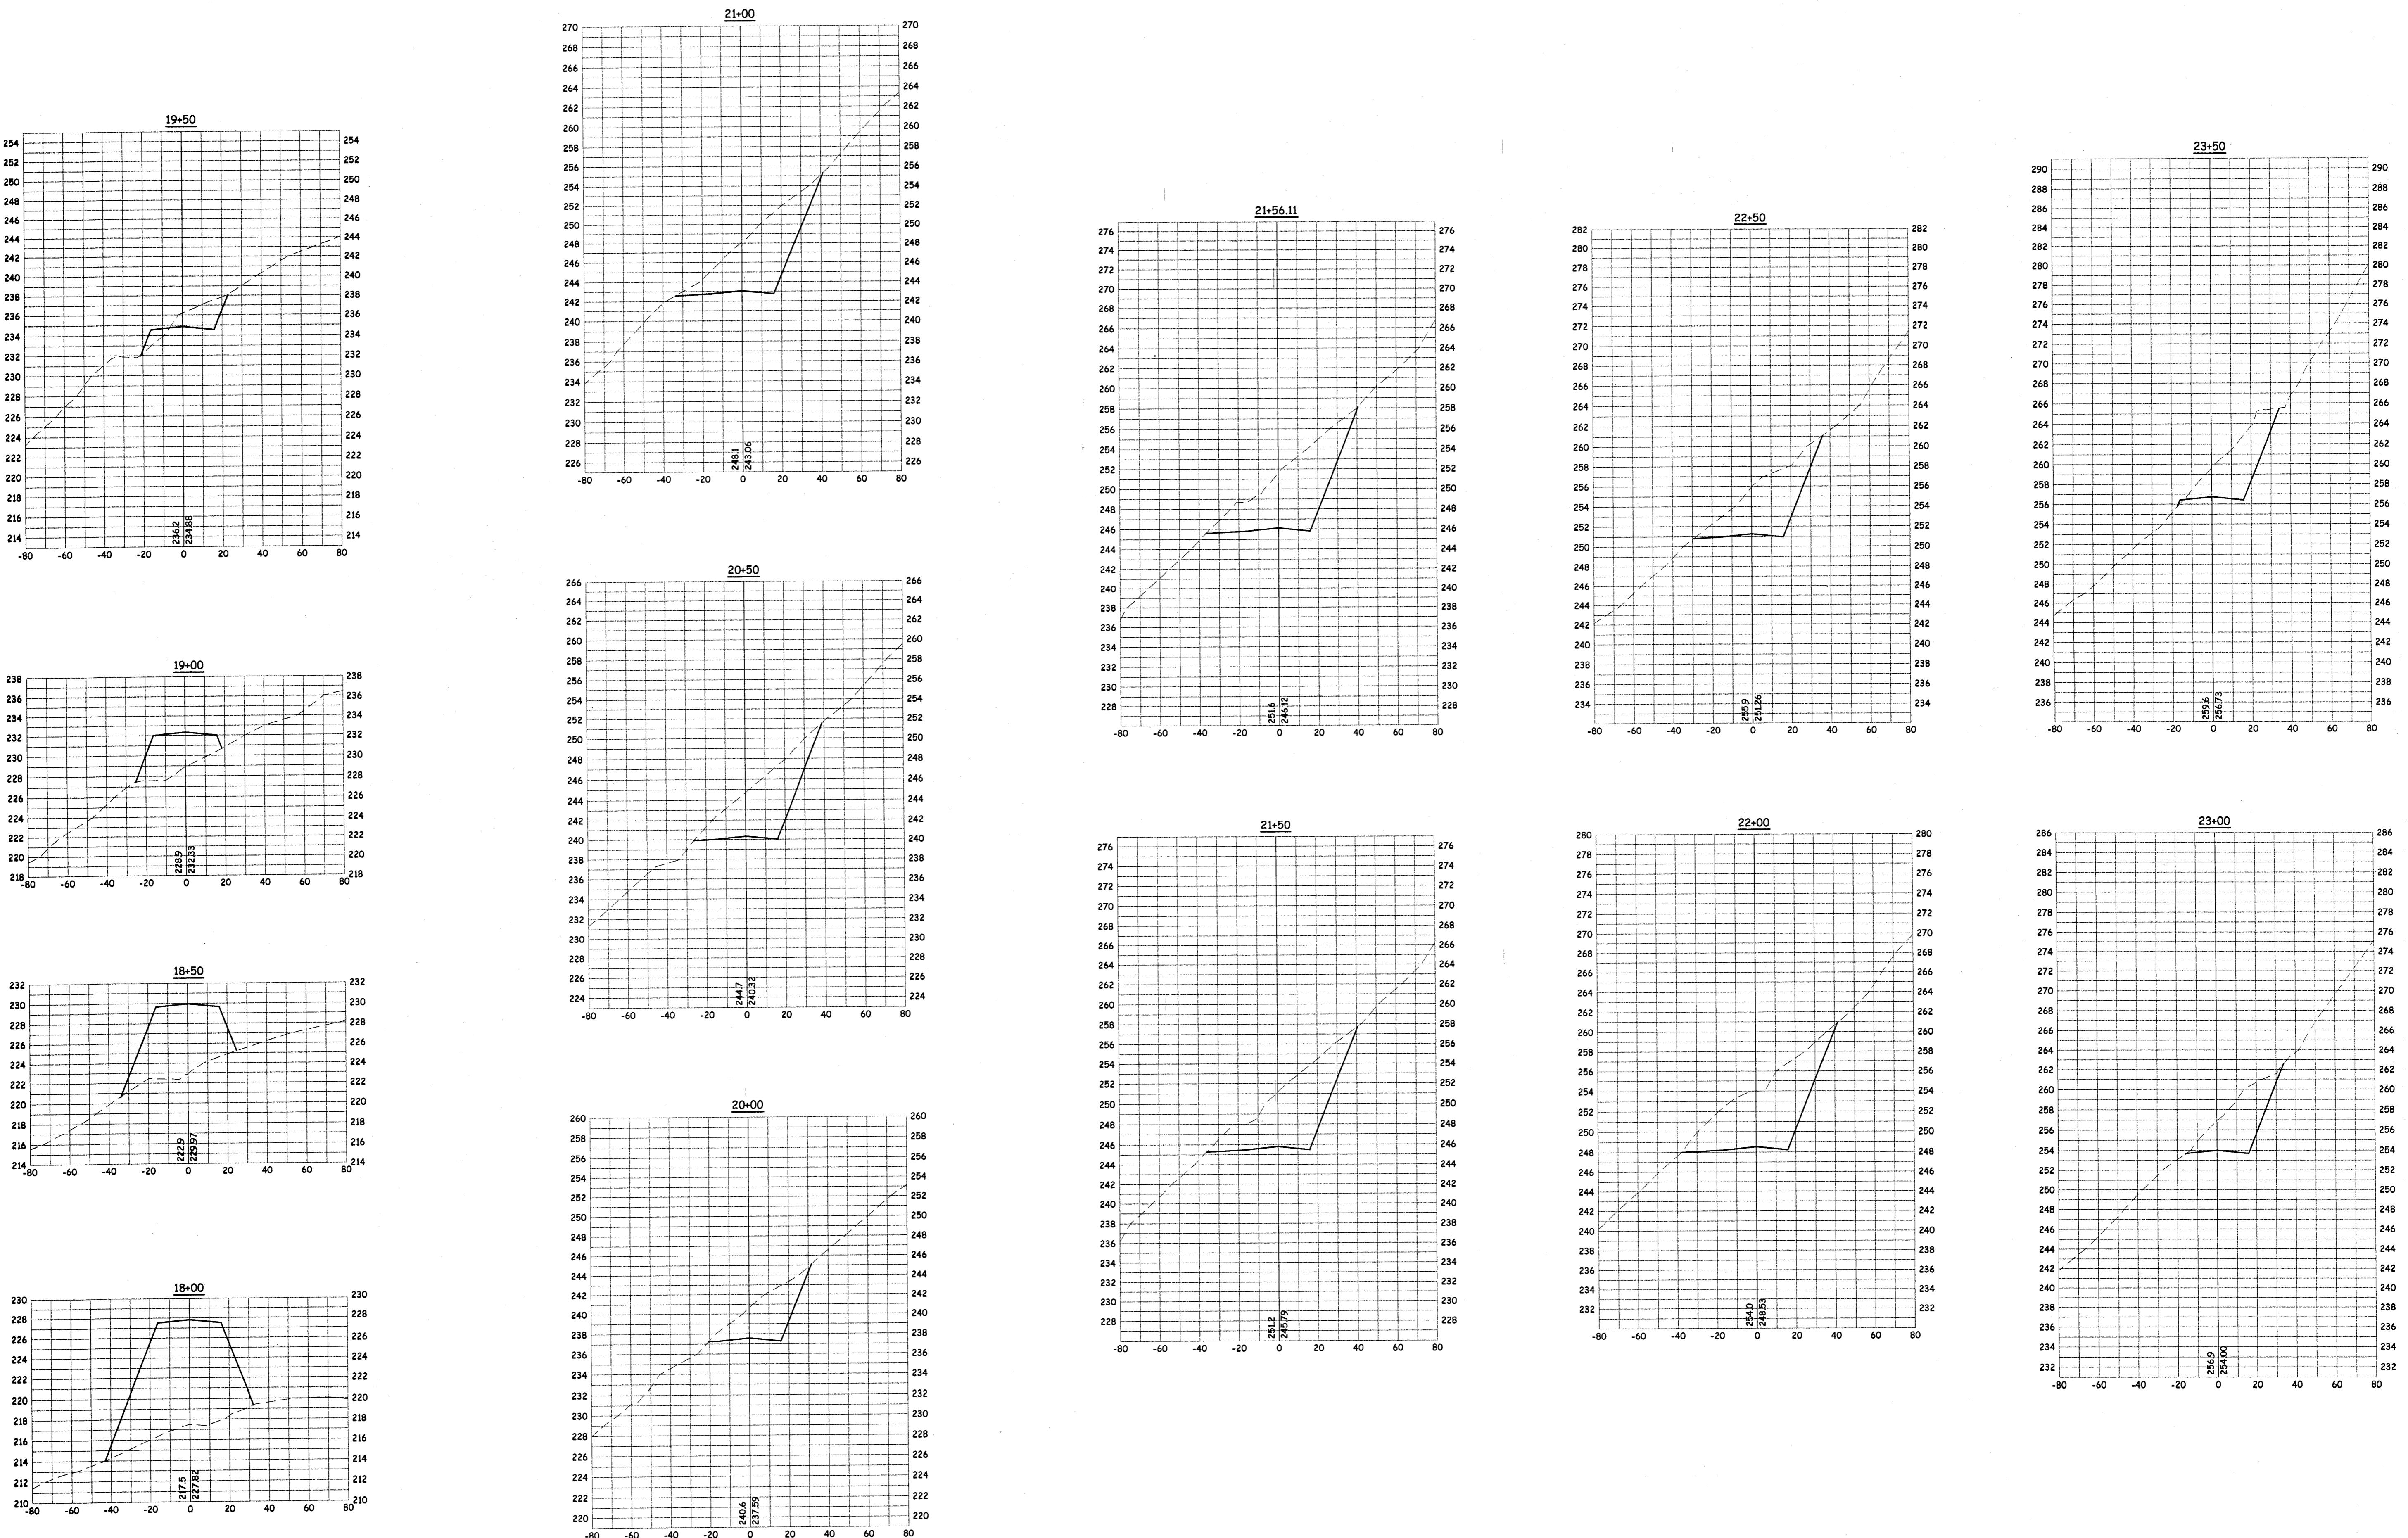

NO.	REVISION DESCRIPTION	BY:	DATE	APPROVED BY:
FILE NAME:	XXX			

DATE: 8/28/03
 SCALE: H:1"=40' / V:1"=8'
 DRAWN: RLS
 DESIGNED: TP
 CHECKED: TP


PREPARED UNDER THE DIRECTION OF:
 BERNARD T. PEDERSEN DATE

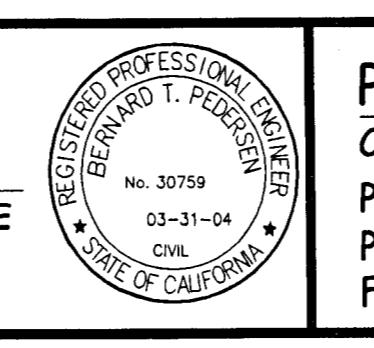

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CROSS SECTIONS - MOKELUMNE OAKS DRIVE
MOKELUMNE OAKS SUBDIVISION

PROJECT # 0206-22
 SHEET
X2 of 7

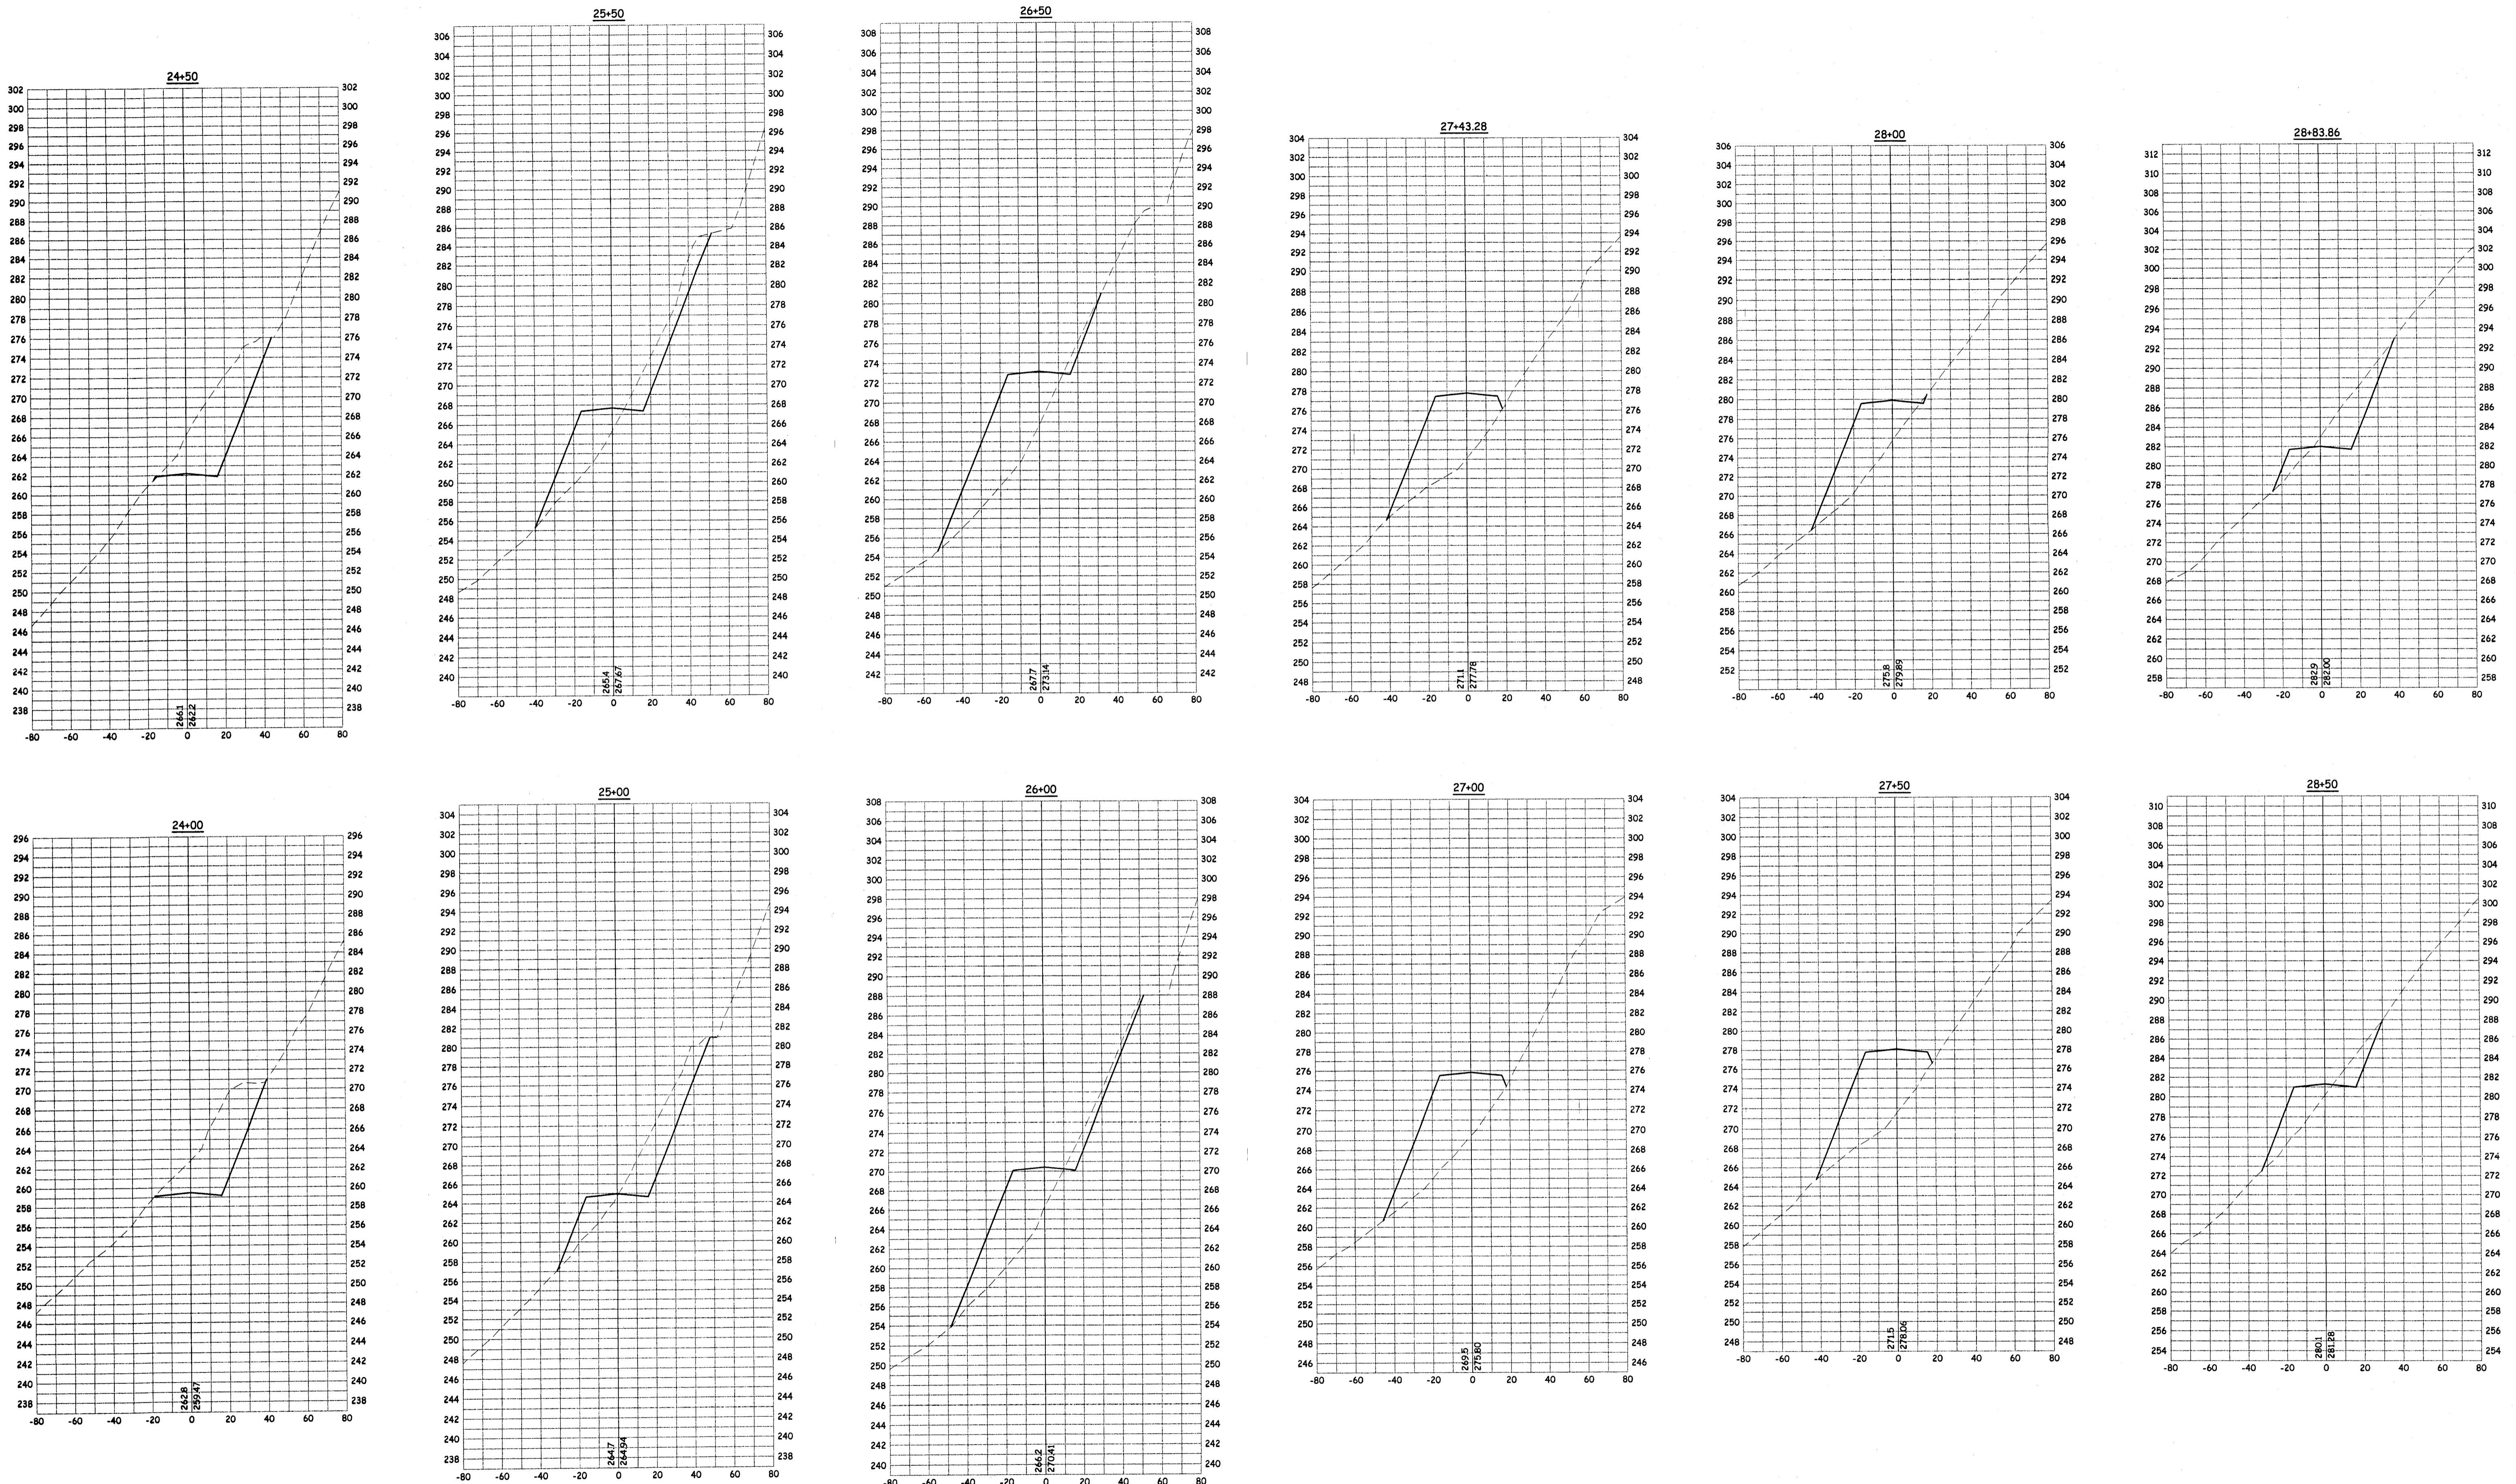


C:\EDERSEN\ENVIRO\Projects\Mokelumne Oaks IMPERIAL\Mokelumne Oaks OnSiteDrainageWhole Oaks X-Sections.dwg, Moke Oaks Drive 3, 1/12/2004 8:26:08 AM, Roger, 1:1

NO.	REVISION DESCRIPTION	BY:	DATE	APPROVED BY:

FILE NAME: XXX

DATE: 8/28/03
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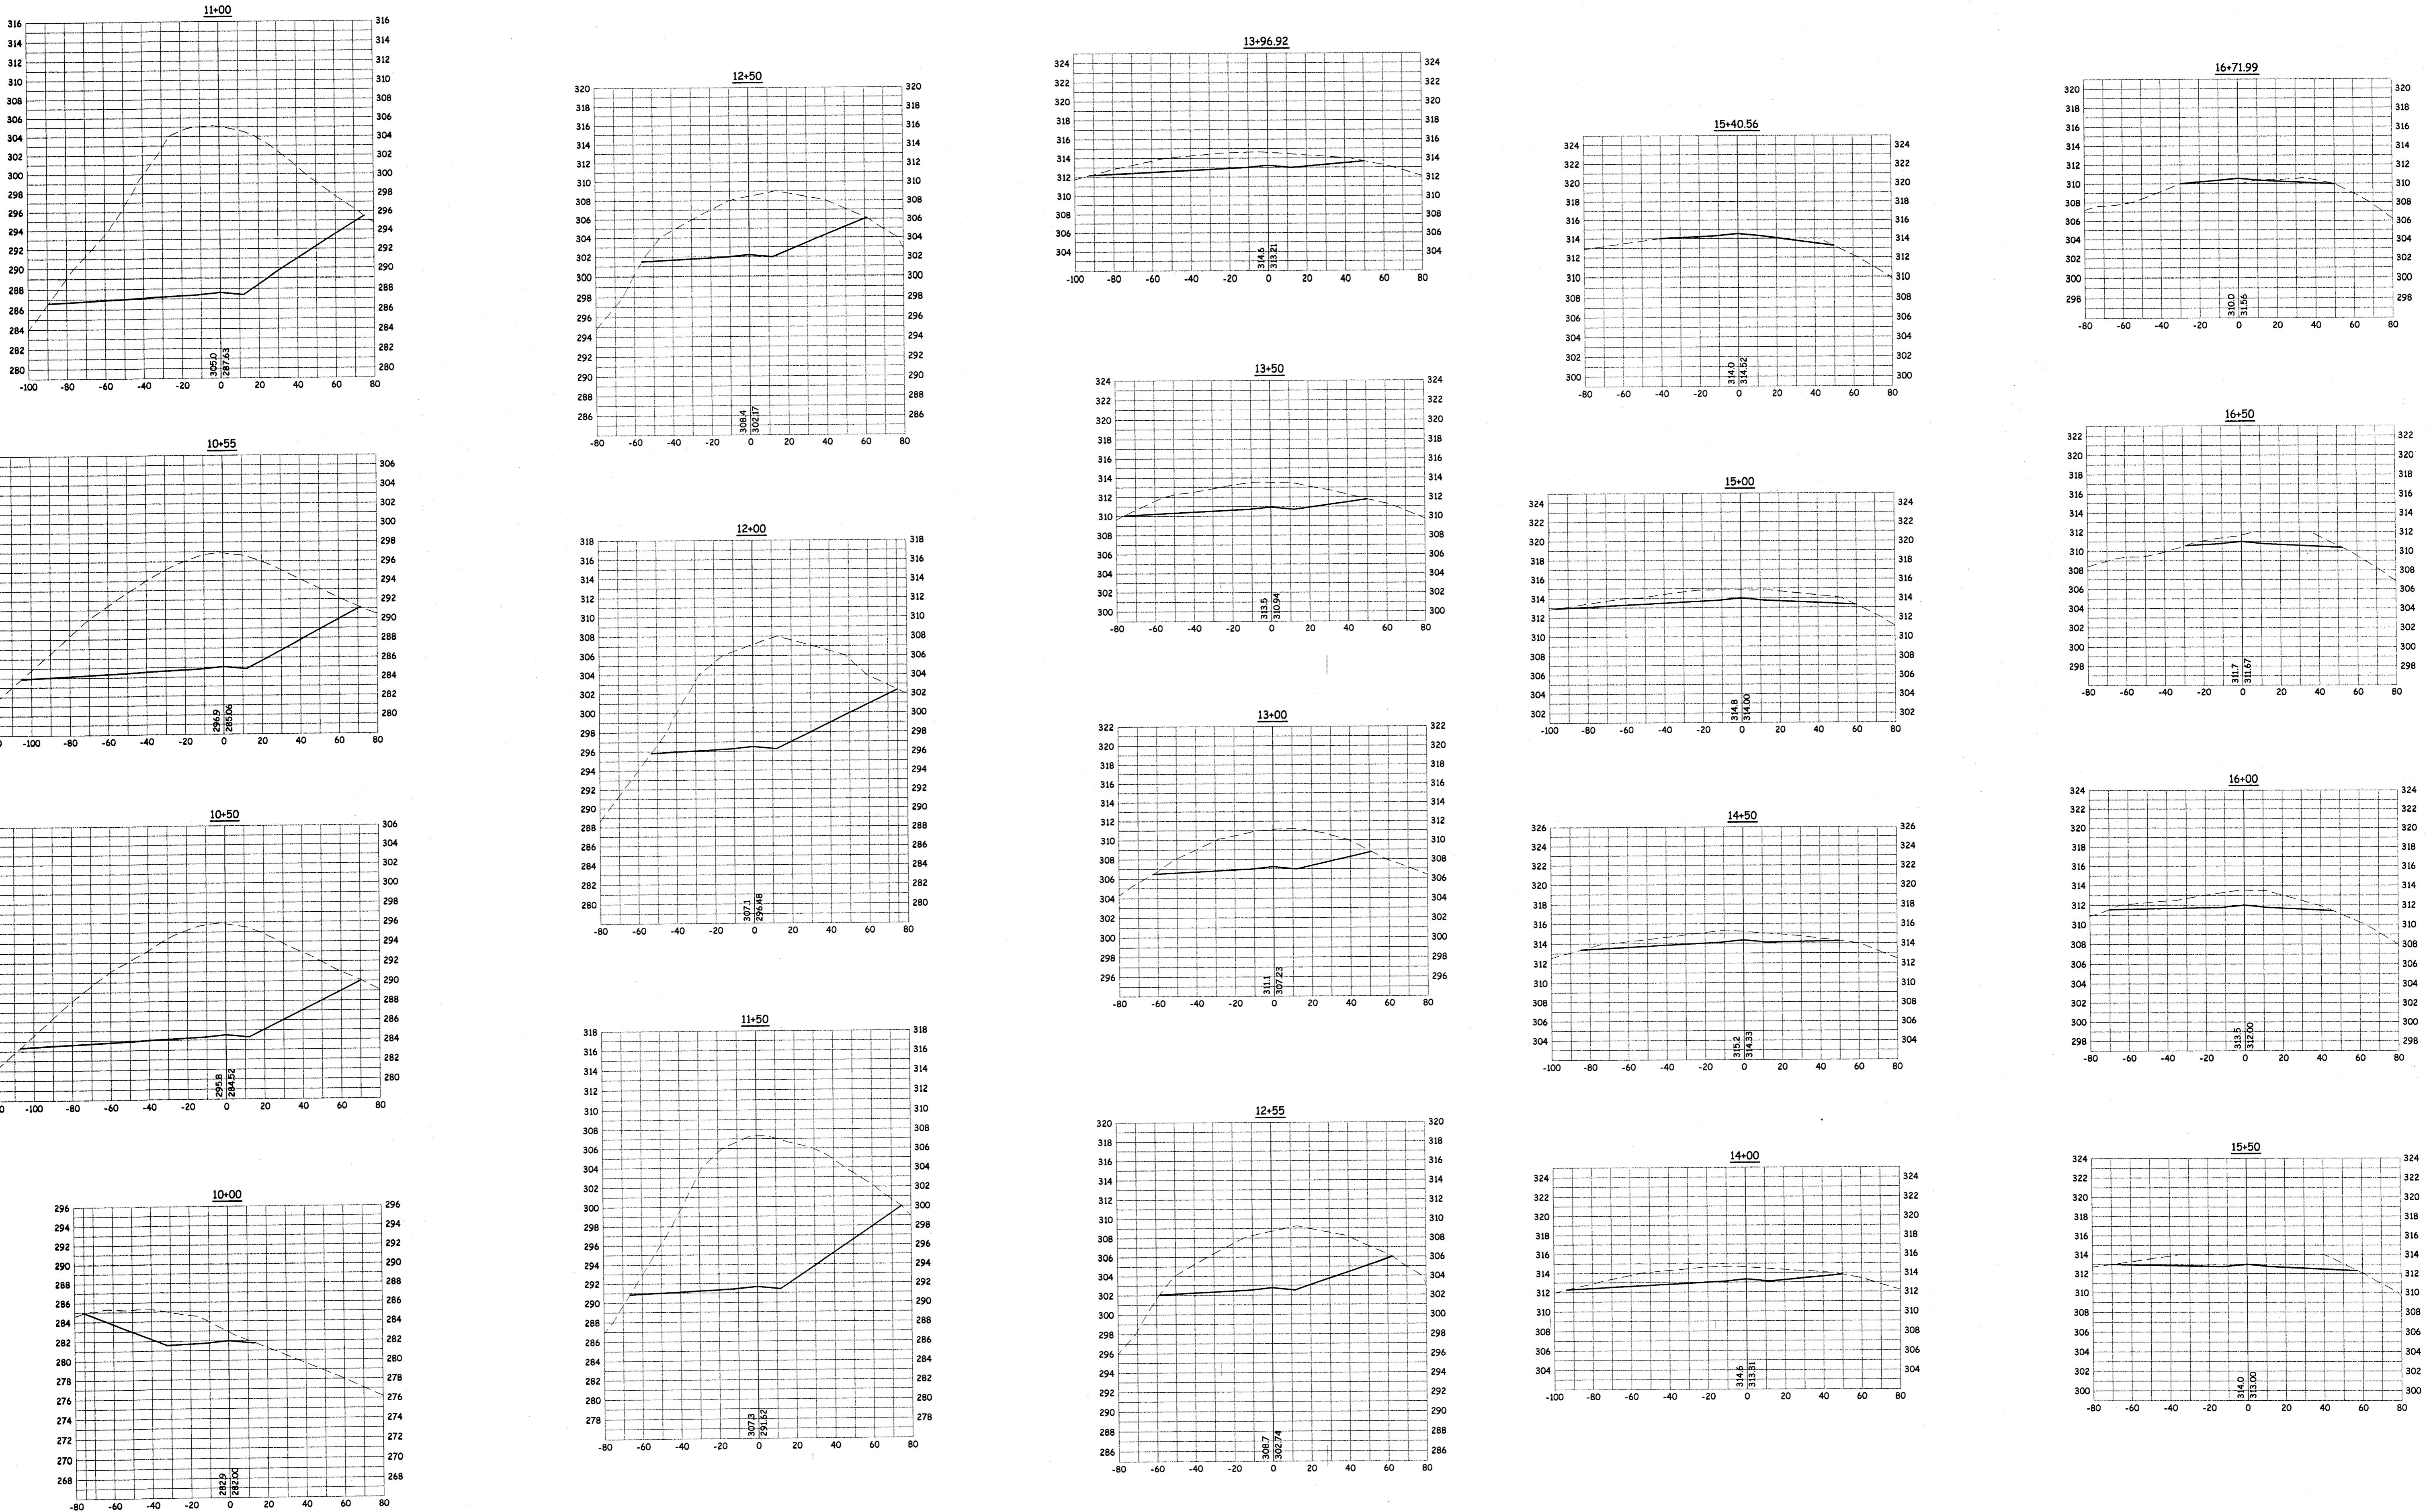
PREPARED UNDER THE DIRECTION OF:
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CROSS SECTIONS - MOKELOMNE OAKS DRIVE
 MOKELOMNE OAKS SUBDIVISION


PROJECT # 0206-22
 SHEET
 X3 of 7

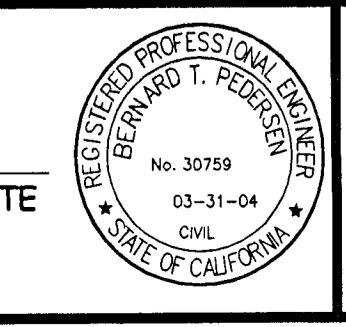

REVISION HISTORY	NO.	REVISION DESCRIPTION	BY:	DATE	APPROVED BY:

DATE: 8/2
SCALE: H:1"=40'
DRAWN: R
DESIGNED:
CHECKED:

PREPARED UNDER THE DIRECTION OF:
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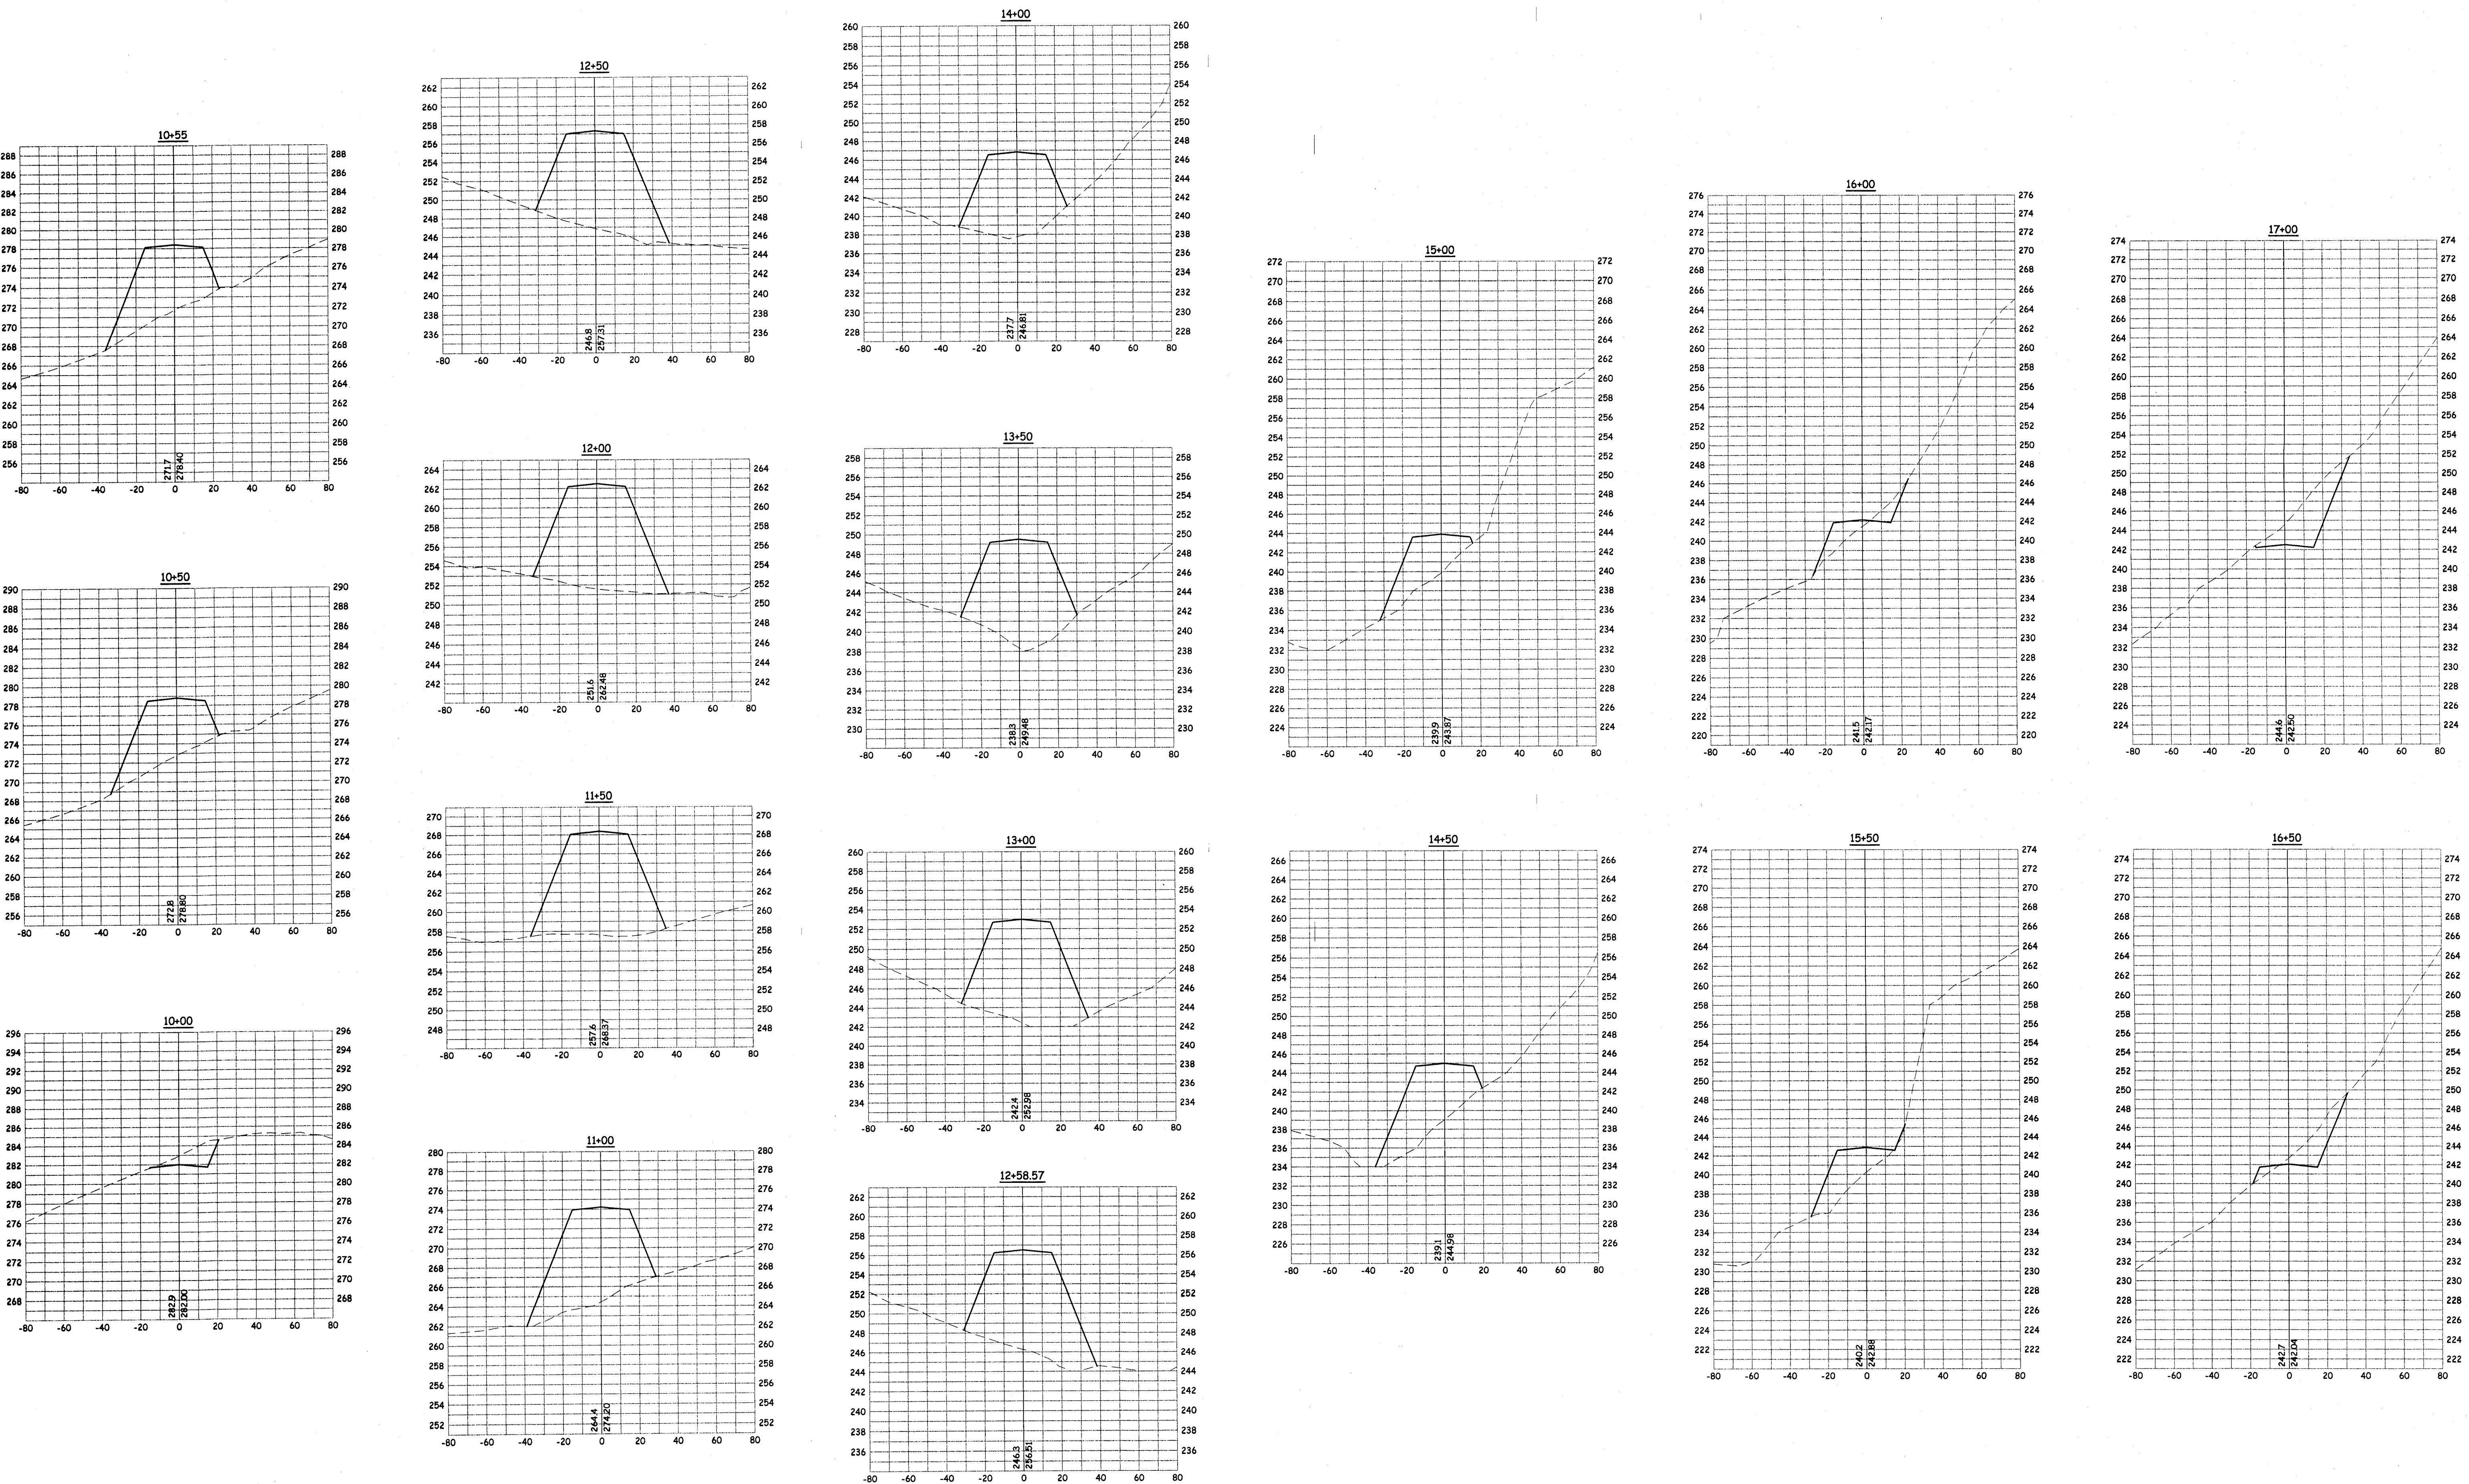
CROSS SECTIONS - ALBION COURT

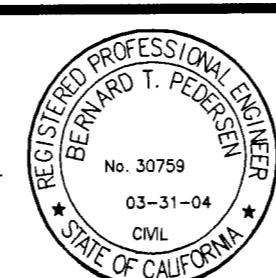MOKELUMNE OAKS SUBDIVISION

PROJECT # 0206-22

SHEET

X4 of 7




PEDERSEN ENGINEERING\Projects\Mokelumne Oaks OnSite\dwg\Wake Oaks X-Sections 40x.dwg, Wallace Pkwy 1, 1/12/2004 8:28:10 AM, Roger, 1:1

NO.	REVISION DESCRIPTION	BY:	DATE	APPROVED BY:
FILE NAME:	XXX			

DATE: 8/28/03
SCALE: H:1"=40' / V:1"=8'
DRAWN: RLS
DESIGNED: TP
CHECKED: TP

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Consulting Civil Engineers
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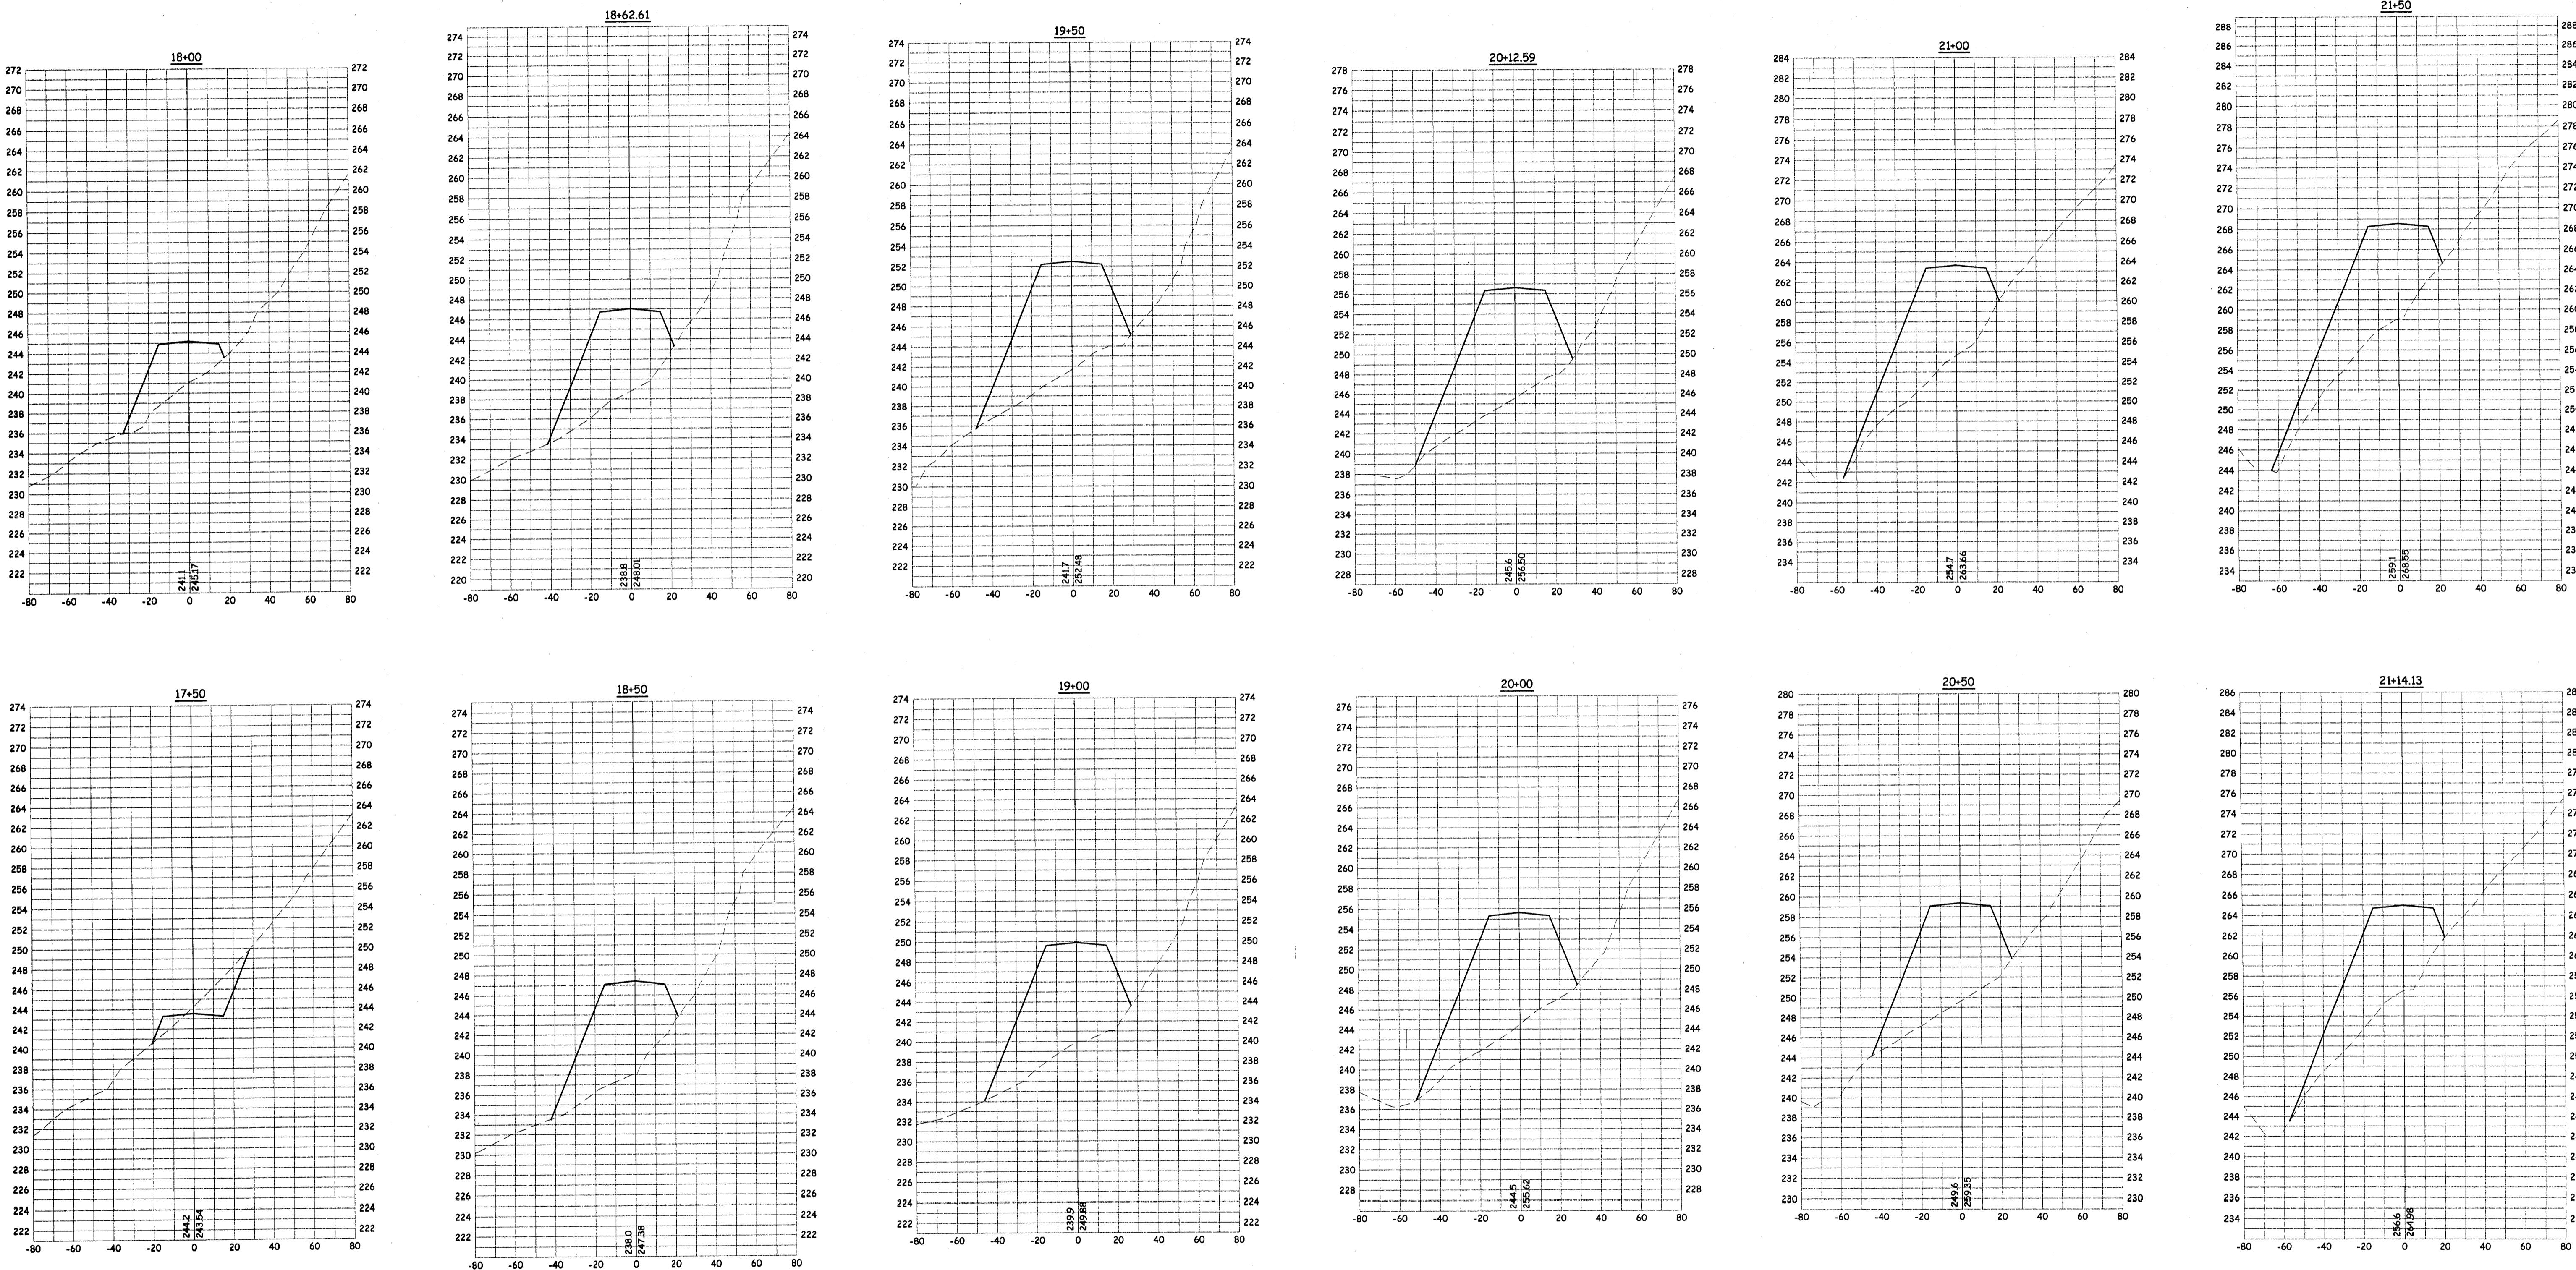
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MOKELUMNE OAKS SUBDIVISION

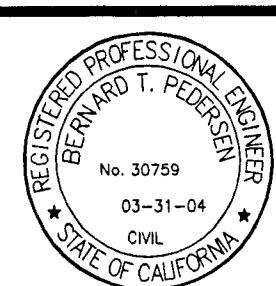PROJECT # 0206-22

SHEET

X5 of 7




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FILE NAME: XXX

DATE: 8/28/03
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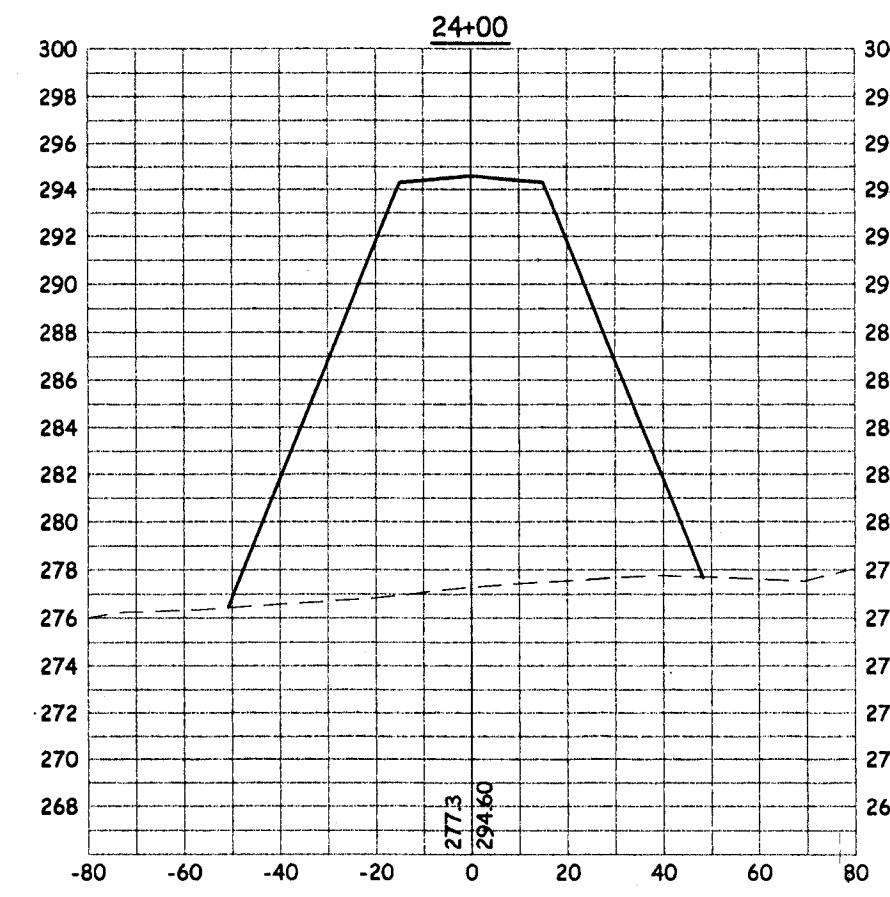
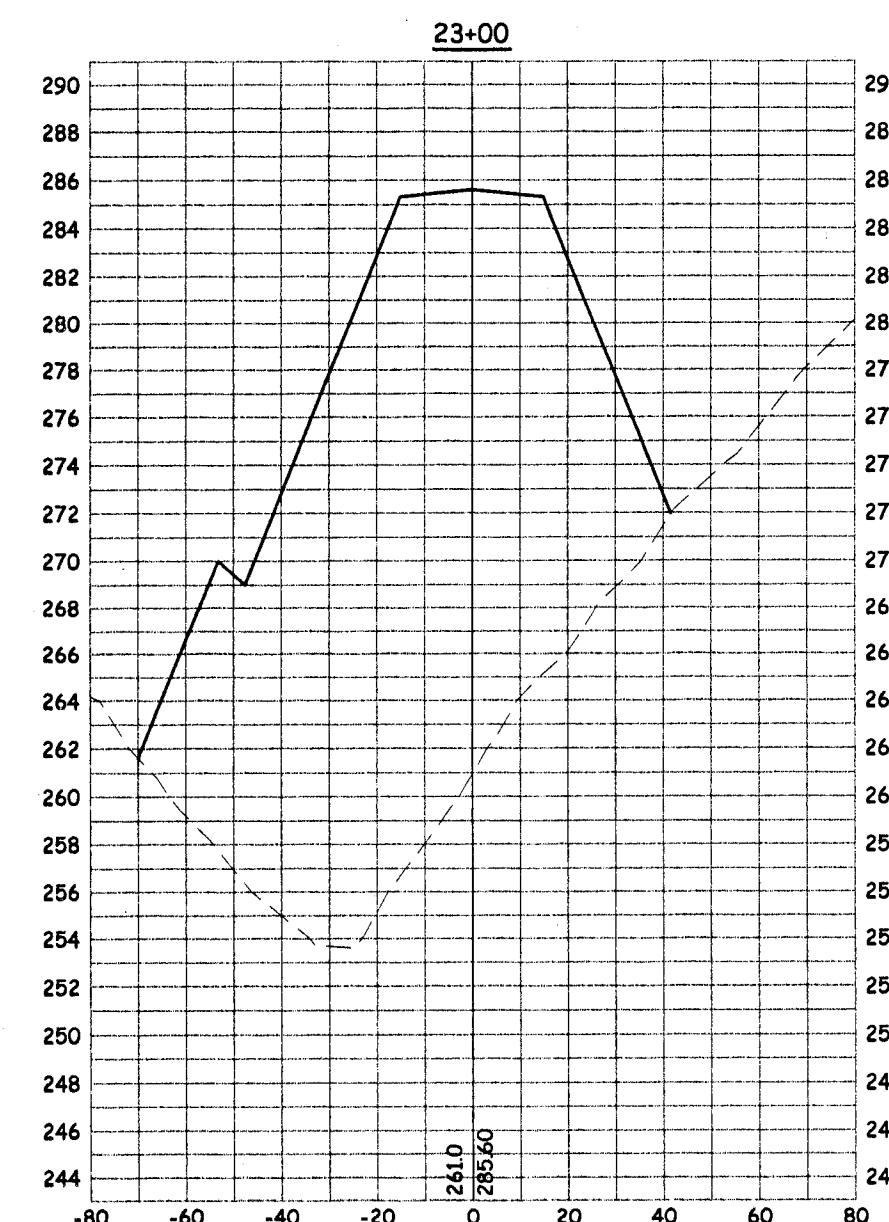
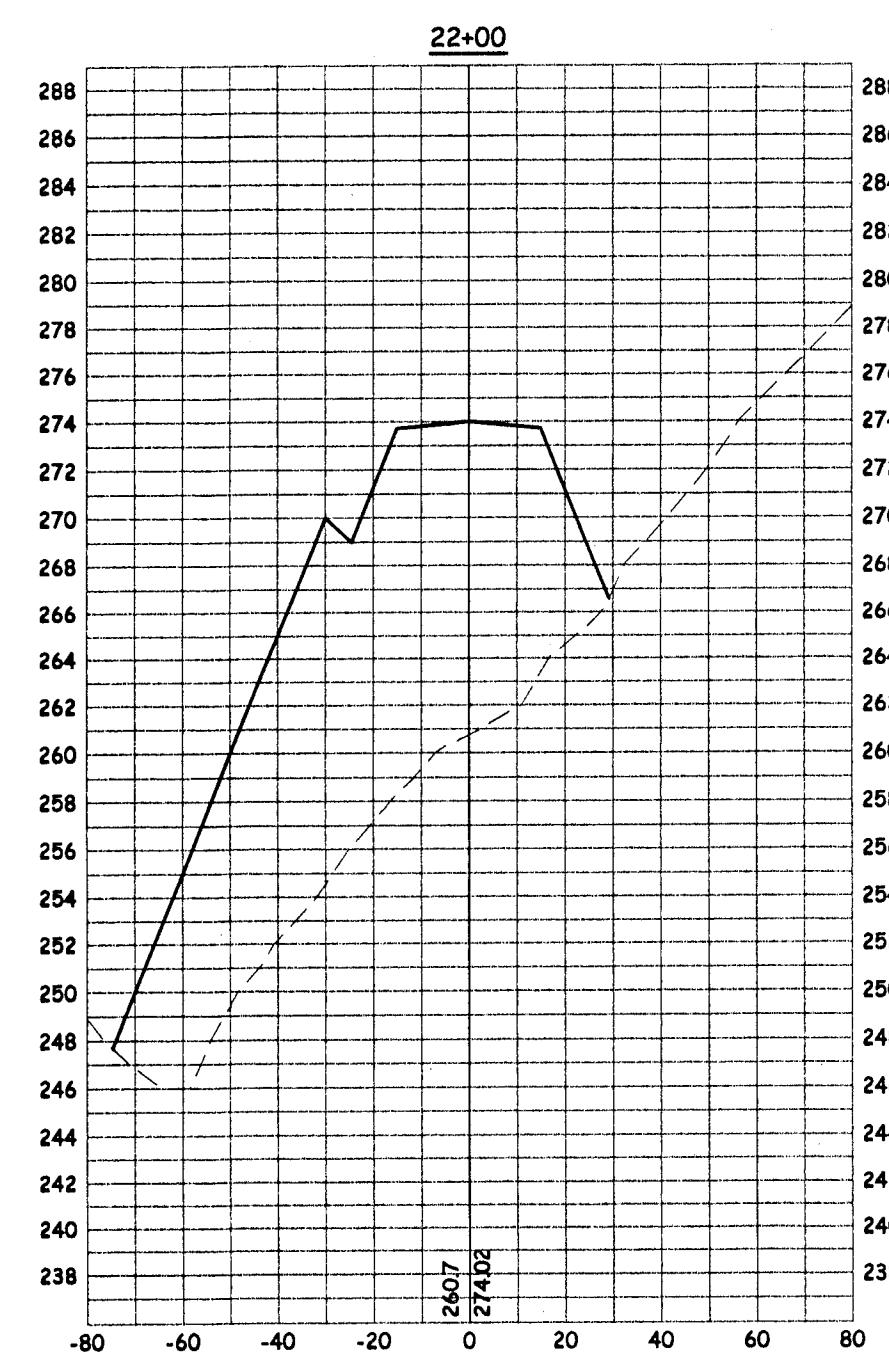
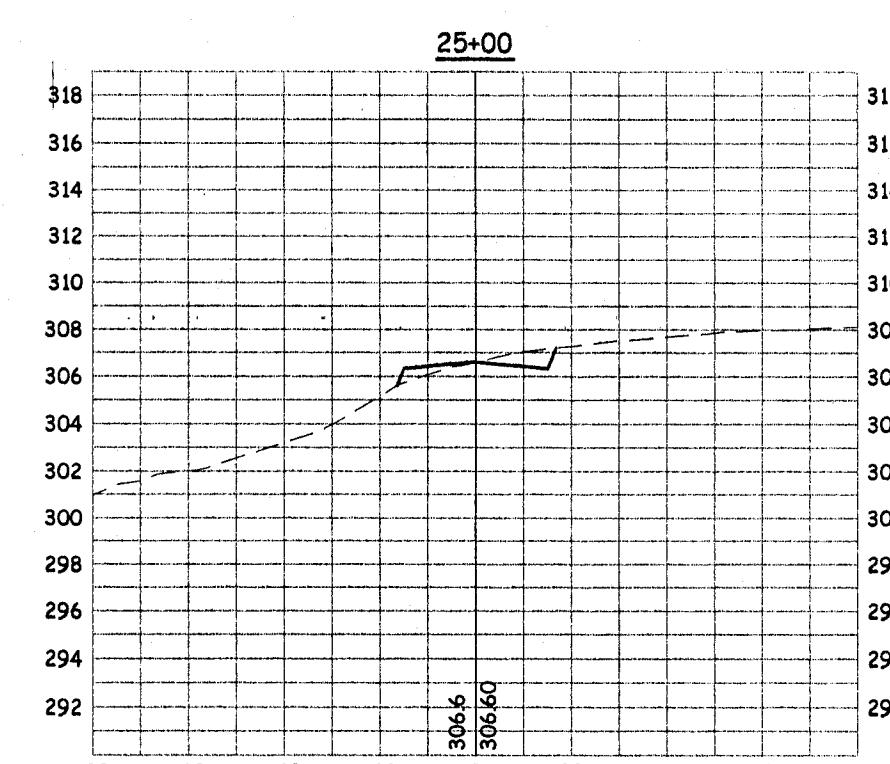
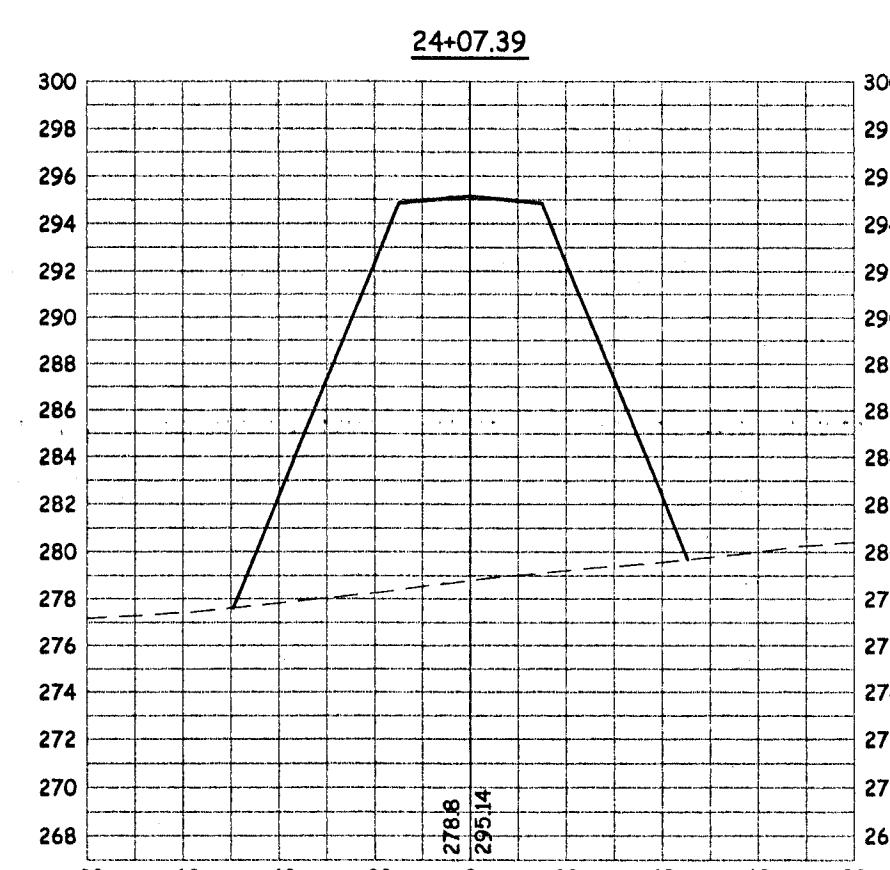
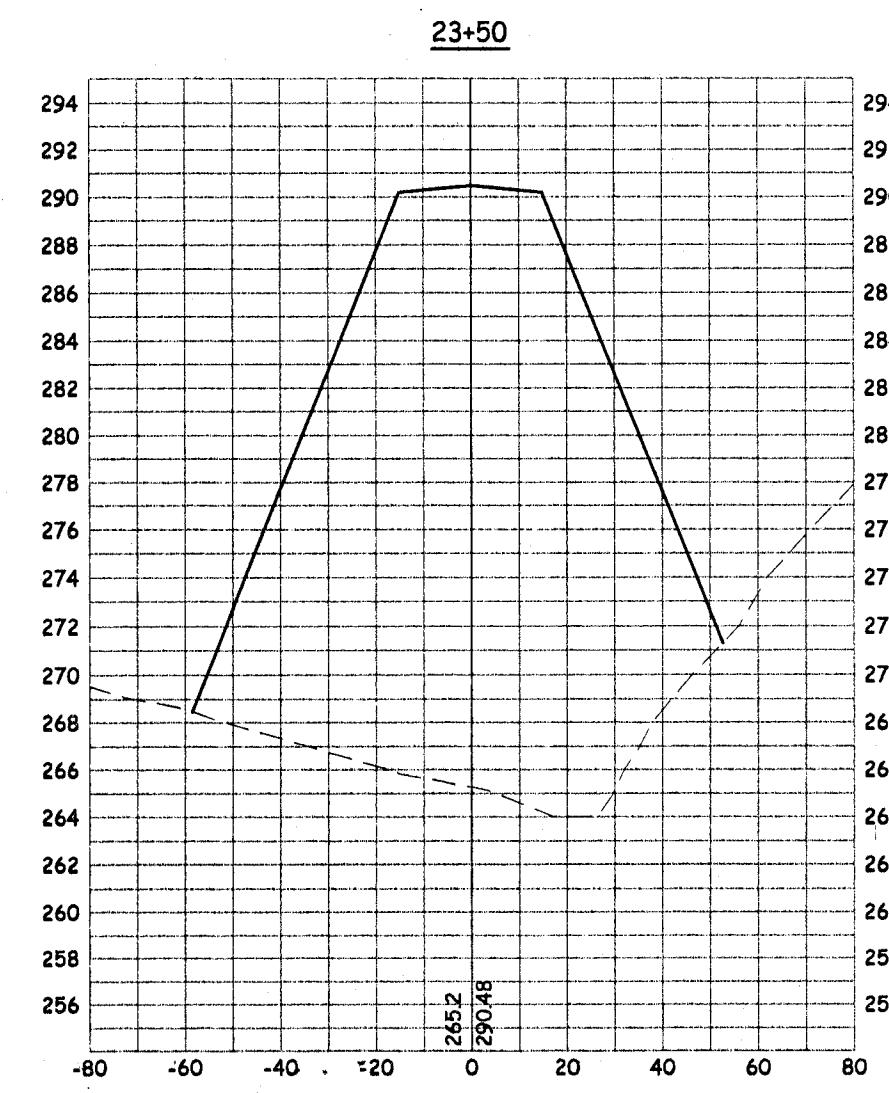
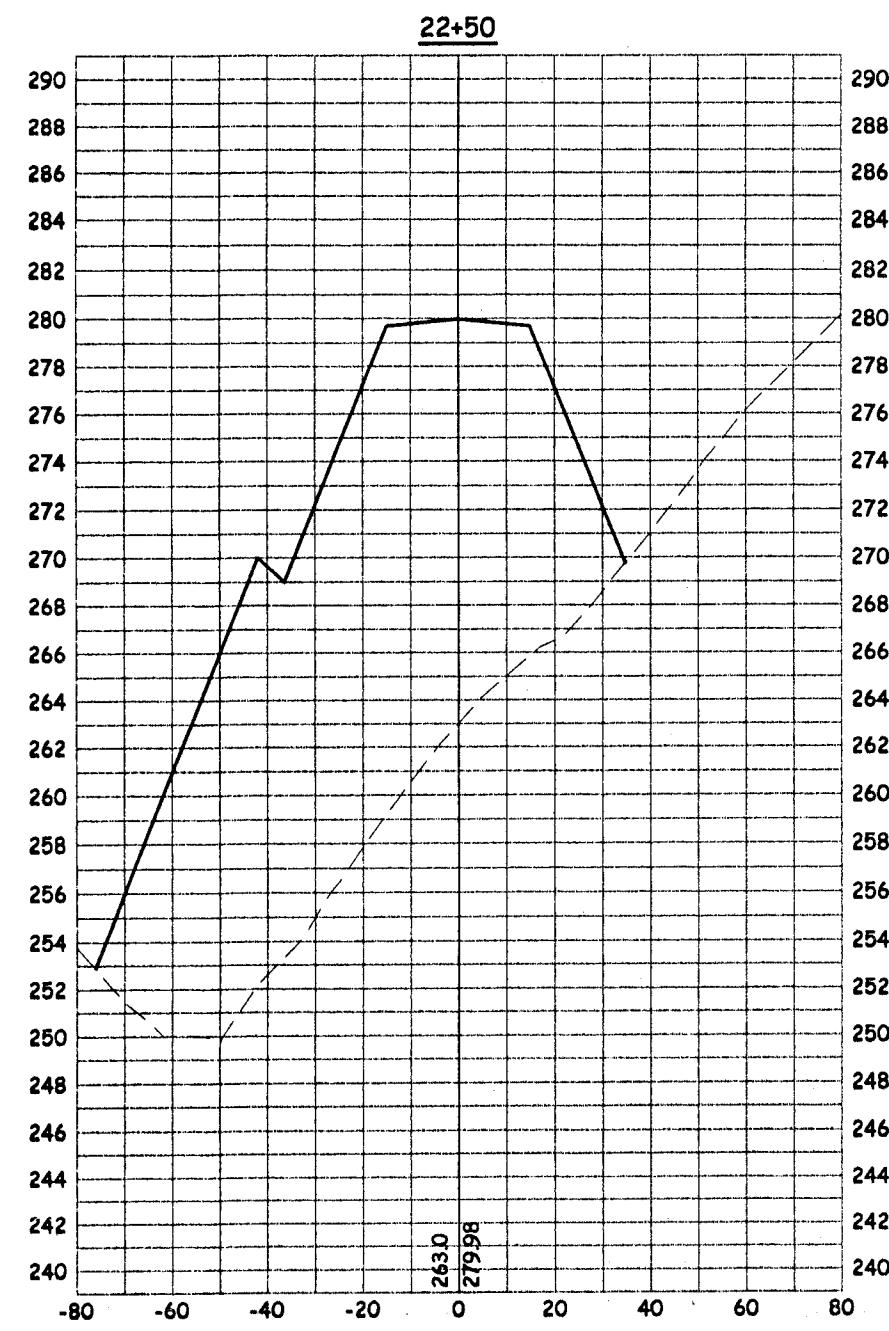
PREPARED UNDER THE DIRECTION OF:
 BERNARD T. PEDERSEN DATE
 *BERNARD T. PEDERSEN
 REGISTERED PROFESSIONAL ENGINEER
 No. 30759
 03-31-04
 STATE OF CALIFORNIA*



Pedersen Engineering Inc.
 Consulting Civil Engineers
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CROSS SECTIONS - WALLACE PARKWAY
MOKELOMNE OAKS SUBDIVISION

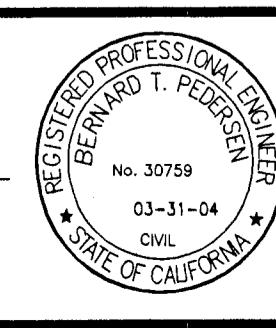PROJECT # 0206-22
 SHEET
X6 of 7



NO.	REVISION DESCRIPTION	BY:	DATE	APPROVED BY:

DATE: 8/28/03
SCALE: H:1"=40' / V:1"=8'
DRAWN: RLS
DESIGNED: TP
CHECKED: TP

PREPARED UNDER THE DIRECTION OF:
BERNARD T. PEDERSEN DATE



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CROSS SECTIONS - WALLACE PARKWAY

MOKELOMNE OAKS SUBDIVISION

PROJECT # 0206-22

SHEET

X7 of 7